ISLAMIC CENTER OF EASTSIDE

14700 MAIN STREET BELLEVUE, WASHINGTON 98007



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SHEET INDEX ARCHITECTURAL TOPOGRAPHIC SURVEY PROPOSED FLOOR PLANS, ROOF PLAN AND BUILDING SECTION PROPOSED EXTERIOR ELEVATIONS RENDERINGS ELECTRICAL PH1 EXTERIOR LIGHTING PLAN C1.0 CIVIL COVER SHEET EXISTING CONDITIONS EROSION CONTROL PLAN C6.1 EROSION CONTROL NOTES AND DETAILS LANDSCAPE PLANTING PLAN RENDERING L3 SITE AMENITIES

VICINITY MAP ABBREVIATIONS OWNER ICOE - ISLAMIC CENTER OF EASTSIDE Flat Bar Plate 14700 MAIN STREET Floor Drain Plastic Laminate BELLEVUE, WA 98007 Foundation Centerline Fire Extinguisher PLYWD. Plywood Diameter or Round Fire Extinguisher Cab Pound or Number Fire Hose Cabinet Paper Towel Dispenser Combination Paper Towe Floor P.T.D/R Flashing ACOUS FLUOR. Fluorescent Paper Towel Receptacle Area Drain Face of Concrete Face of Finish AGGR. Face of Mullion Aluminum F.O.SH. Face of Sheathing APPROX. FPRF. F.S. Fireproof ARCH. Radius Full Size ASB. R.D. Roof Drain ARCHITECT Asbestos ASPH. REF. Asphalt Reference FTG. Refrigerator FURR. RGTR. PROJECT SITE Bituminous Reinforced BLDG. Required WARE MALCOMB Block Galvanized BLKG. Blocking Beam Rough Opening 3015 112TH AVENUE NE, SUITE 205 BELLEVUE, WASHINGTON 98004 Bottom of Concrete RWD. Redwood Bottom of Mullion Grade Bottom of Panel B.O.R. Bottom of Reveal Self Adhered Flashing Hose Bibb Solid Core Hollow Core SE 16TH ST. Seat Cover Dispenser Hardwood Catch Basir Schedule Hardware H.M. Hollow Metal Ceramic HORIZ. Horizontal Cast Iron NO SCALE Corner Guard Sheet CLKG. Caulking Inside Diameter Closet Sanitary Napkin Disp. Insulation Clear S.N.R. Sanitary Napkin Recept. SYMBOLS CONSULTANTS Interior Cased Opening SPEC. Column Center of Mullion Stainless Steel Joint CONC. S.SK. STA. Concrete Service Sink Kitchen Connection Knock Out CONSTR. Construction ----- INTERIOR ELEVATION VIEW Standard STRUCTURAL ENGINEER CONT. Continuous - INTERIOR ELEVATION REFERENCE Center of Reveal Laminate ENGINEERS NW INC. CORR. Structural OFFICE CTSK. CNTR. Lavatory Countersunk Suspended ROOM NAME LKR. Locker Counter Symmetrical SEATTLE, WASHINGTON 98115 Light Center 0000 -ROOM NUMBER Towel Bar — WALL MATERIAL TYPE Department M.C. Medicine - TYPE NUMBER Telephone Mechanical DOOR NUMBER Membrane Tongue and Groove **ELECTRICAL ENGINEER** DIA. DIM. DISP. Diameter Metal C ----- FLOOR MATERIAL TYPE Dimension Manufacturer Top of Concrete SCHNACKEL ENGINEERS - TYPE NUMBER 1411 4TH AVE., SUITE 1000 Minimum Top of Reveal EXISTING DOOR Door Opening ----- MISC. MATERIAL TYPE MIR. Mirror T.O.RC. SEATTLE, WASHINGTON 98101 Top of Deep Recess MISC. Miscellaneous T.O.M. Top of Mullion — TYPE NUMBER Masonry Opening T.O.W. Top of Wall Downspout MTD. Mounted Top of Pavement Dry Standpipe MUL. T.P.D. Mullion Toilet Paper Dispenser XXX KEYNOTE INDICATOR --- DETAIL REFERENCE Drawing Television **CIVIL ENGINEER** T.W. Top of Wall SHEET NUMBER Not In Contract N.I.C. TYP. Typical Each WARE MALCOMB NO. Number XXX FINISH INDICATOR UNF. Unfinished Expansion Joint Nominal U.O.N. UR. 4683 CHABOT DR. #300 Unless Otherwise Noted Elevation X The Detail Section Reference N.T.S. Not To Scale Electrical Urinal PLEASANTON, CALIFORNIA 94588 Elevator VERT. Vertical EMER. Emergency VEST. Vestibule Obscure Enclosure West

- SHEET NUMBER

— EXTERIOR ELEVATION REFERENCE

FIRE EXTINGUISHER CABINET

W/ FIRE EXTINGUISHER

WALL-MOUNTED FIRE

EXTINGUISHER

Electrical Panelboard

Electric Water Cooler OPNG.

Equipment

Existing

Exposed Expansion

Exterior

EXPO.

EXP. EXT.

On Center

Office

Opening

Outside Diameter (Dim.)

With

Wood

Without

Wainscot Weight

Water Closet

Wheather/Water

Resistive Barrier

Waterproofing Membrane


PROJECT DATA **BUILDING DEPARTMENT:** CITY OF BELLEVUE 2015 INTERNATIONAL BUILDING CODE — WAC 51-50 2015 INTERNATIONAL EXISTING BUILDING CODE — WAC 51-50-480000 2015 INTERNATIONAL MECHANICAL CODE — WAC 51-52 **BUILDING CODES:** 2015 INTERNATIONAL FIRE CODE - WAC 51-54 2015 WASHINGTON STATE ENERGY CODE - WAC 51-11 2015 UNIFORM PLUMBING CODE AND STANDARDS - WAC 51-56 AND WAC 51-57 ASSESSOR'S PARCEL NO.: _ 342505-9026 PROJECT SCOPE INCLUDES NEW CONSTRUCTION OF TWO STORY CULTURAL CENTER BUILDING OCCUPANCY CLASSIFICATION: __ TYPE OF CONSTRUCTION: _ SPRINKLERED: 30 FT (DECORATIVE SPIRE HEIGHT IS EXEMPT) ALLOWABLE NUMBER OF STORIES: ______ 3 PROPOSED BUILDING AREA: SECOND FLOOR = TOTAL AREA = **CHAPTER 9 - FIRE PROTECTION SYSTEMS** (903.3.1.1) AUTOMATIC SPRINKLER SYSTEM WILL BE PROVIDED. (903.4) AUTOMATIC FIRE ALARM SYSTEM WILL BE PROVIDED. THE CITY OF BELLEVUE PROVIDES MAILED NOTICING (INCLUDING LABELS) TO ALL PROPERTY OWNERS WITH 500 FEET OF ANY BOUNDARY OF THE SUBJECT PROPERTY. IN CONJUNCTION WITH PUBLISHING THE NOTICE OF APPLICATION, THE CITY WILL INSTALL A 2-SIDES PUBLIC INFORMATION SIGN ON THE SITE FOR PROJECTS REQUIRING DESIGN REVIEW. THE APPLICANT WILL PAY \$230 PER SIGN.

TRE 4700

WARE Leading Design

PA / PM: DRAWN BY: SC JOB NO.: SEA18-0022-

SHEET

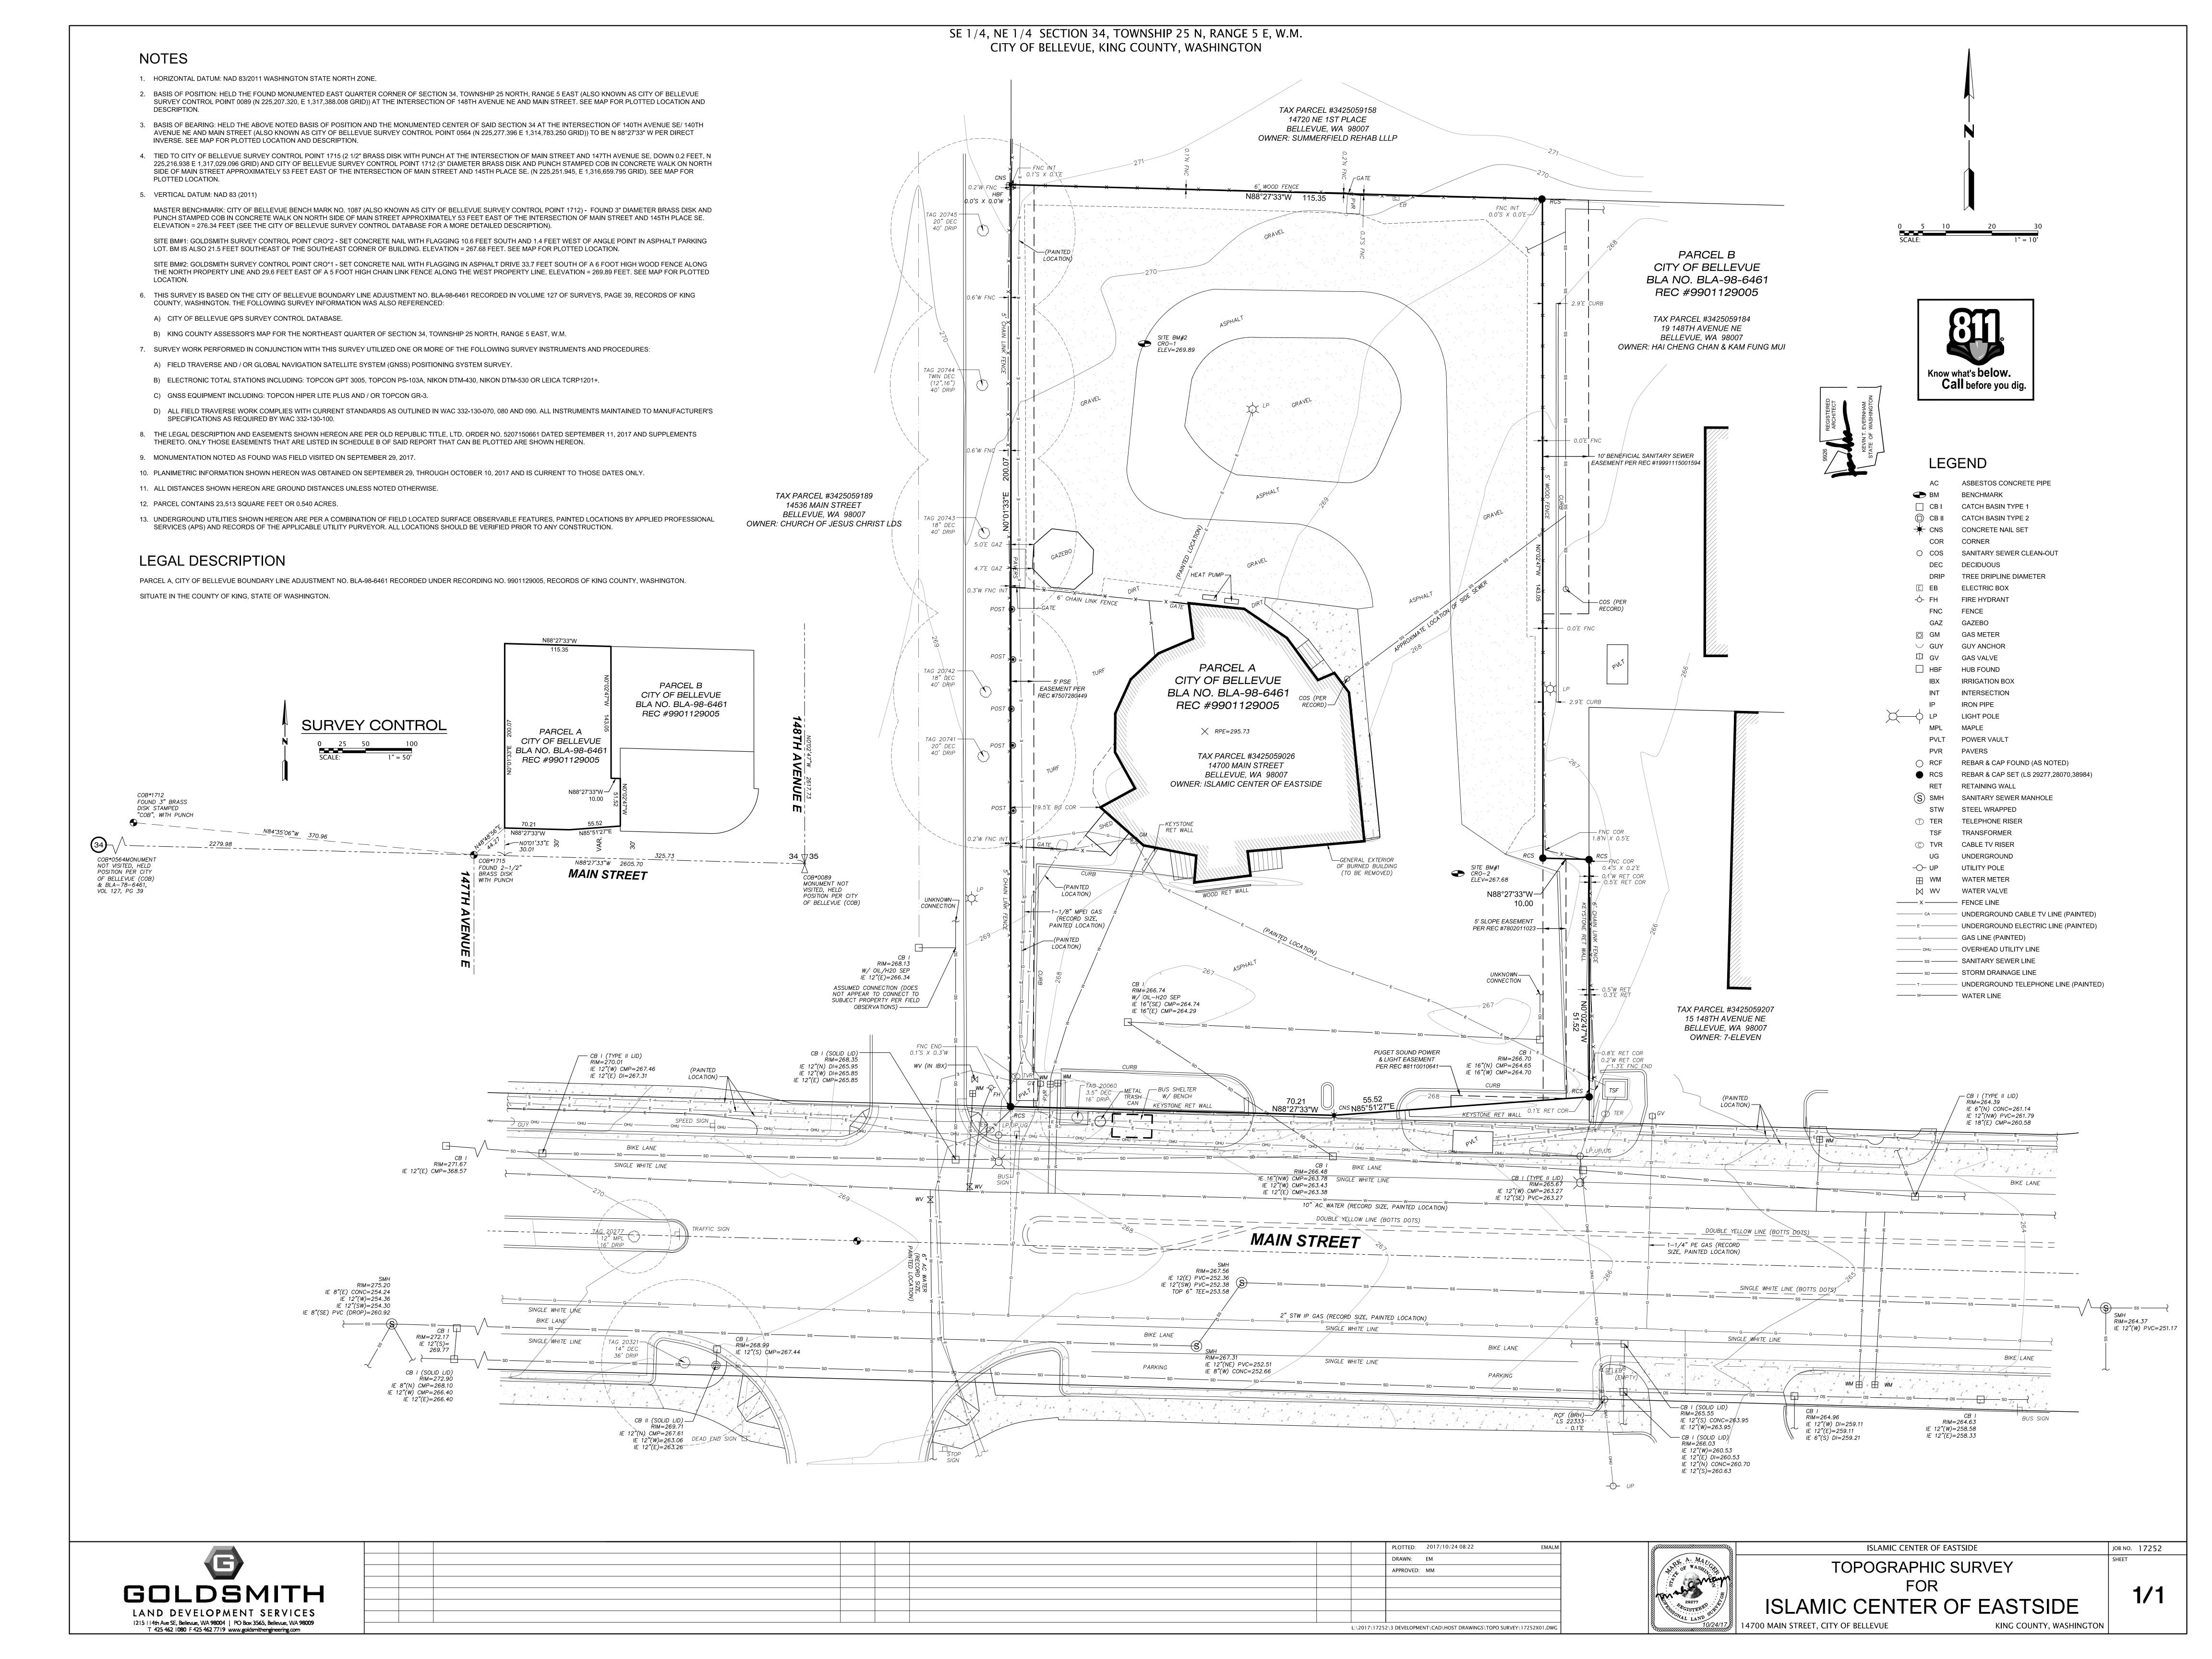

NOTE: SEE CIVIL, LANDSCAPE AND ELECTRICAL DRAWINGS FOR ADDITIONAL SITE PLAN INFORMATION.

9 0" CURB.

PROJECT DATA:

SITE AREA:

FAR:

GROSS:

GROSS:

AUTO:

ZONING:

MAX. F.A.R.:

MAX. COVERAGE:

BUILDING SETBACKS:

LANDSCAPE SETBACKS:

MAX. HEIGHT:

FRONT:

REAR:

FRONT:

SIDE:

REAR:

LANDSCAPE REQ.:

STANDARD:

COMPACT:

COMPACT %:

DRIVE AISLE:

FIRE LANE:

OVERHANG:

OFF-STREET PARKING:

PARKING REQUIRED:

PARKING PROVIDED:

ASSEMBLY

COVERAGE:

GROSS:

BUILDING AREA:

2-STORY BLDG

1ST FLOOR:

2ND FLOOR:

TOTAL BUILDING AREA:

REQ. ACCESSIBLE

DEVELOPMENT STANDARDS:

ACCESSIBLE PROVIDED

(ONE VAN ACCESSIBLE)

SITE PLAN NOTES 2 ACCESSIBLE PARKING STALL WITH SIGNAGE. 3 PAINTED PARKING STRIPING PER CITY STANDARDS. 4 EXISTING TRANSFORMER TO REMAIN. 5 LANDSCAPE AND IRRIGATION AREA. 6 TRASH ENCLOSURE WITH RECYCLE BIN. SEE $\begin{pmatrix} 1 \\ A1.2 \end{pmatrix}$ 7 MONUMENT SIGN. 8 EXISTING CURB CUTS TO REMAIN.

0.54 AC

23,513 SF

2,553 SF

2,332 SF

4,885 SF

0.21

11%

EXEMPT

23 STALLS

1 STALLS

2 STALLS

@4.71/1000 SF

1/100 SF

O (OFFICE)

35%

30 FT

30 FT

20 FT

30 FT

10 FT

10 FT

SF/STALL

8.33X18

7.5X15

50% MIN.

20 FT MIN.

2 FT

20 FT (TRANSITION, 15FT PROVIDED)

WARE MALCOMB
Leading Design for Commercial Real Estate

DRAWN BY: SC JOB NO.: SEA18-0022-0

ADJACENT PROPERTY; PARCEL # 342505-9158

17 PARKING STALLS ADJACENT PROPERTY; PARCEL # 342505-9184 20'-0" 5 TYP. 6 PARKING STALLS ADJACENT PROPERTY; PARCEL # 342505-9207 TSF PVLT 8

MAIN STREET

1" = 10'

1111


0 5 10

ADJACENT PROPERTY;

PARCEL # 342505-9026

SCALE: 1"=10'-0"

CAUTION: IF THIS SHEET IS NOT 30"x42" IT IS A REDUCED PRINT

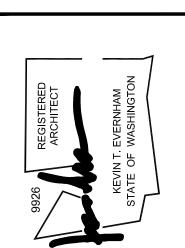

ELEVATION NOTES

1 BRASS

2 ANODIZED DARK BRONZE BY ALPOLIC

3 DURANGO TRAVERTINE BY TERRACORE PANEL: VEIN CUT

4 HALF HEX TILE AT ENTRY AND TOWER BASE


5 CUSTOM MOZ METAL PANEL WITH ISLAMIC PATTERN, FINISHED TO MATCH DARK BRONZE

6 VITRO SOLARBRONZE GLASS

7 CUSTOM PERFORATED METAL PANEL. COLOR TO MATCH ALPOLIC ANODIZED DARK BRONZE 8 SIGNAGE. COLOR TO MATCH ALPOLIC ANODIZED DARK BRONZE

9 LANDSCAPE WATER FALL

10 PAINTED STAINLESS STEEL RAILING. COLOR TO MATCH ALPOLIC ANODIZED DARK BRONZE

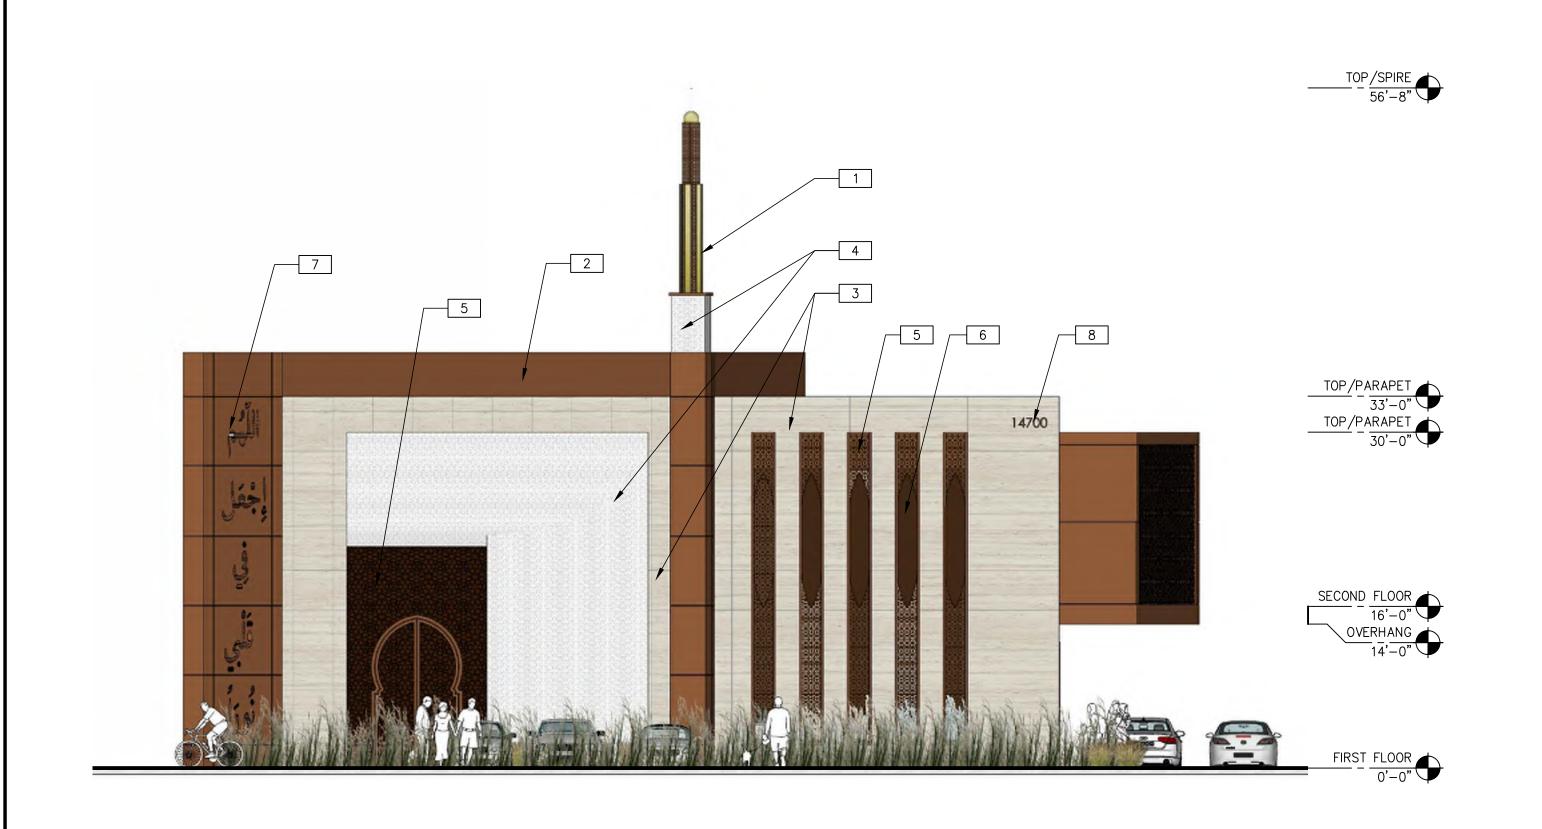





SOUTH EXTERIOR ELEVATION

SCALE: 1/8" = 1'-0"

EAST EXTERIOR ELEVATION

SCALE: 1/8" = 1'-0"

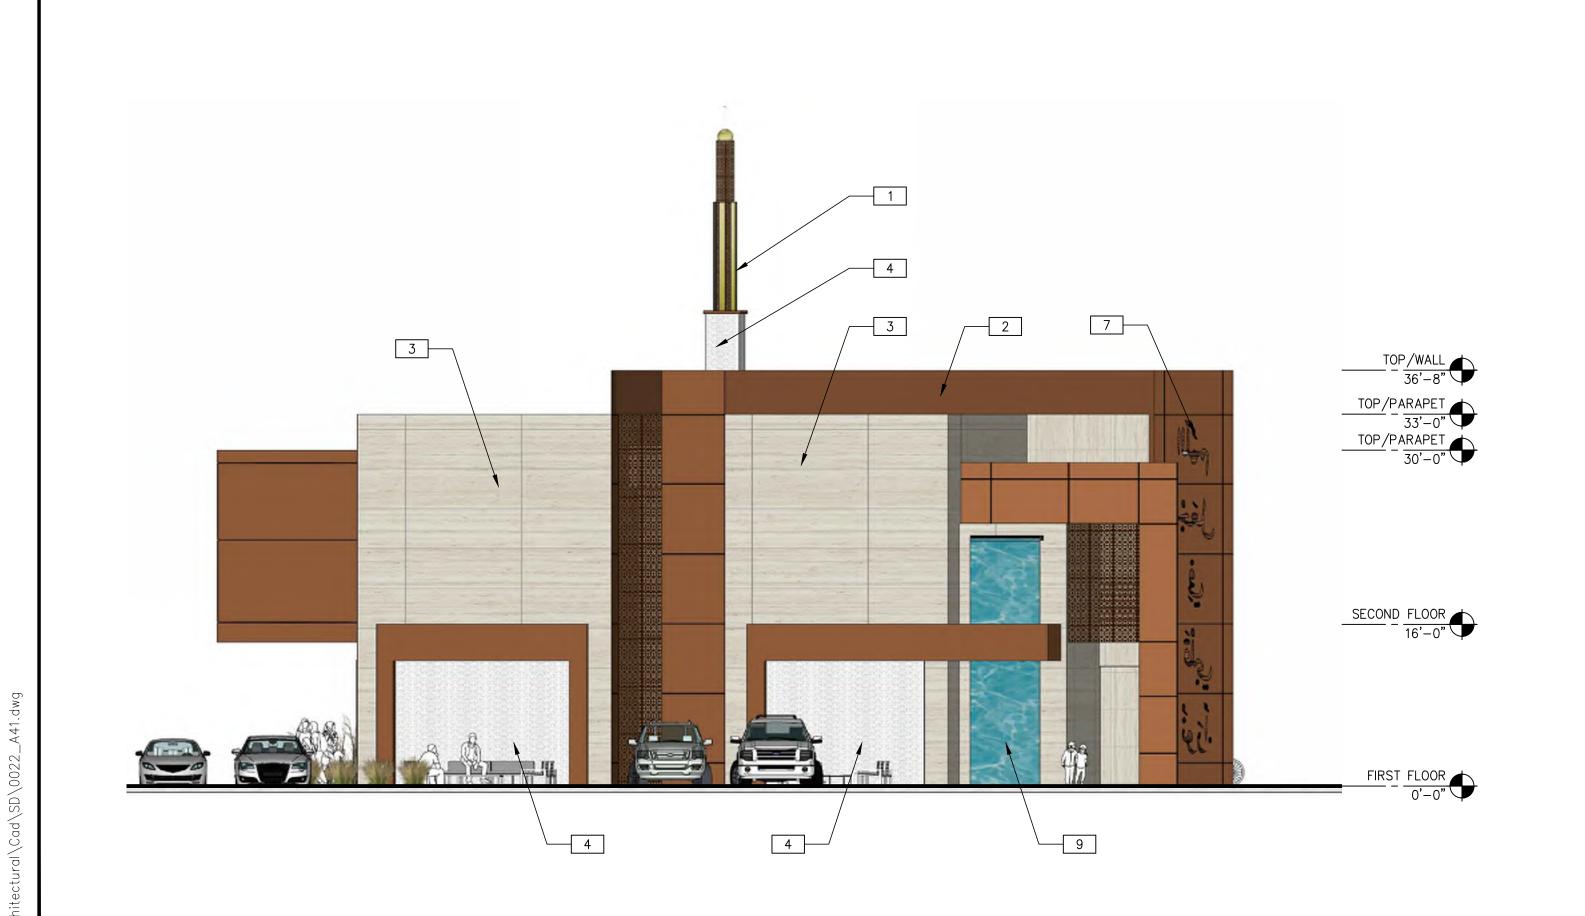

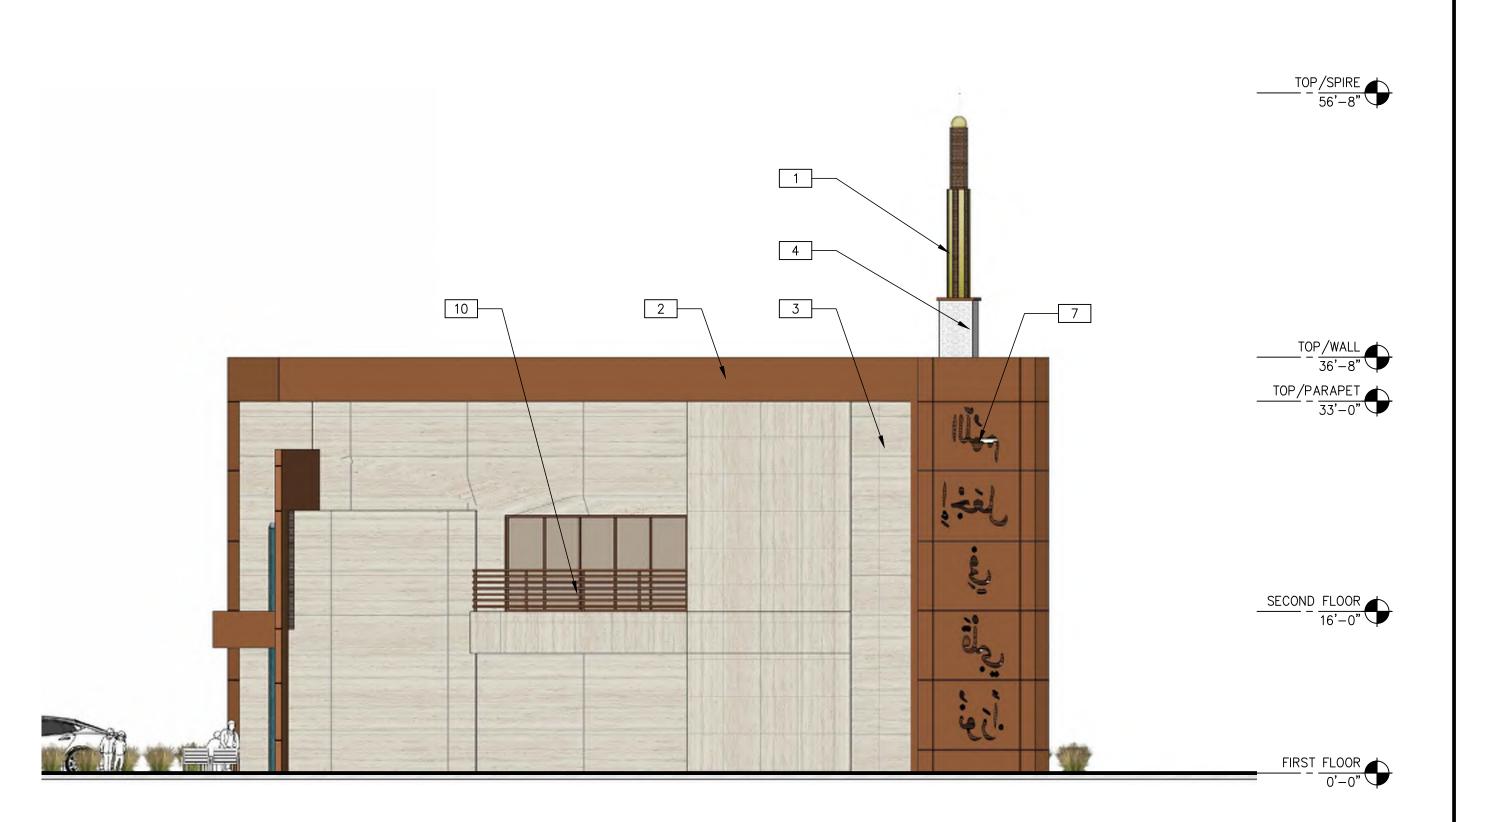

NORTH EXTERIOR ELEVATION

SCALE: 1/8" = 1'-0"


WEST EXTERIOR ELEVATION

SCALE: 1/8" = 1'-0"

MALCOMB for Commercial Real Estate WARE Leading Design

TREE 98007 14700 MAIN BELLEVUE, W

JOB NO.: SEA18-0022-0

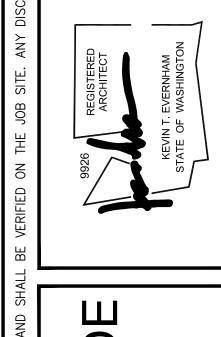


DRAWN BY: SC JOB NO.: SEA18-0022-0

 $\overline{\mathsf{B}}$





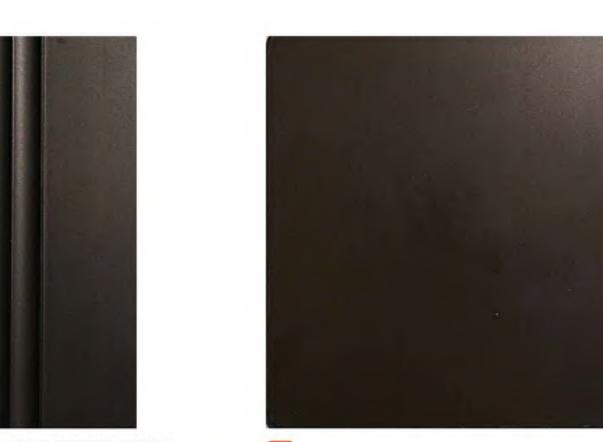





3 ALPOLIC: ANODIZED DARK BRONZE






7 HALF HEX TILE AT ENTRY



5 TERRACORE PANEL: VEIN CUT DURANGO TRAVERTINE

1 VITRO SOLARBRONZE GLASS



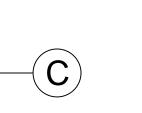


ISLAMIC CENTER AT EASTSIDE

CLEARING AND GRADING PLAN

14700 MAIN STREET BELLEVUE, WA 206-310-5127

DEFINITION NEW EXISTING DEFINITION DEFINITIO	## 27 MINE PROPERTY PROPERTY	UTILITY PROVIDERS	LEGEND	ABBREVIATIONS	VICINITY MAP
CAB	CELL IN BROOKER 20-THE CHARGE HARD STREET	450 110TH AVENUE NE BELLEVUE, WA 98004 (425) 452–6800 ATER CITY OF BELLEVUE	PROPERTY LINE ADJACENT PROPERTY LINE CENTERLINE MONUMENT LINE EASEMENT BUILDING LINE FOUND MONUMENT AS NOTED STREET LIGHT TRAFFIC SIGNAL POLE TRANSFORMER SANITARY SEWER MANHOLE STORM DRAIN MANHOLE PUMP STATION BUBBLE UP CATCH BASIN AREA DRAIN CLEAN OUT FIRE HYDRANT WATER METER BACKFLOW PREVENTER FIRE DEPARTMENT CONNECTION DOUBLE CHECK DETECTOR ASSEMBLY POST INIDICATOR VALVE BLOW-OFF VALVE AUTOMATIC SPRINKLER RISER SIGN TREE W: SIZE AND ELEVATION SPOT ELEVATION SPOT ELEVATION 15 15 15 15 16 17 18 19 10 10 10 10 10 10 10 10 10	CB	Bellevue Botanical Garden Kelsey Creek Park Creek Park SE No. 32 Lake Hills GreenBelt Park Lake Hills GreenBelt Park SE No. 32 Lake Hills GreenBelt Park SE No. 32 Lake Hills GreenBelt Park Bellevue Botanical Garden Kelsey Creek Park Lake Hills GreenBelt Park SE No. 32 Lake Hills GreenBelt Park By SE No. 32 Lake Hills GreenBelt Park DATEO SEPTEMBER 17, 2018. PROJECT NO. 2018-172 By The RILEY GROUP, INC. BOTHELL WA, 98011 By: DATE
CONCRETE AREA BIO-RETENTION AREA REPLACING EXISTING DEVELOPED AREA. CITY OF BELLEVUE FIRE DEPARTMENT CITY OF BELLEVUE FIRE DEPARTMENT	REPLACING EXISTING DEVELOPED AREA. CITY OF BELLEVUE FIRE DEPARTMENT THE PREVENTION PROTECTION PANCER CITY OF BELLEVUE ENGINEERING CITY OF BELLEVUE ENGINEERING DATE		RIDGE — — R— — — CURB & GUTTER — — — — — — CONCRETE — — — — — — — FENCE — — — — — — — — — SANITARY SEWER — SS — — — — — — — — STORM DRAIN — — — — — — — — — — — — PERFORATED PIPE — — — — — — — — — — — — — — — WATER — — — — — — — — — — — — — — — — — — —	DESCRIPTION OF PROPOSED ACTIVITIES PROVIDING GRADING, DRAINAGE, & UTILITY DESIGN FOR THE CONSTRUCTION OF TWO STORY BUILDING	MICHAEL MURPHY, P.E. DATE
·	NAME: DIRECTOR OF PUBLIC WORKS/CITY ENGINEER DATE				

JOB NO.: SEA18-0022
PA / PM: KN / GP
DRAWN BY: SY
DATE: 10-17-2018

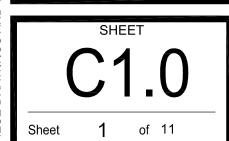

- 1. EROSION AND SEDIMENT CONTROL MEASURES SHALL BE EFFECTIVE FOR THE DURATION OF THE CONSTRUCTION ACTIVITY.
- 2. EARTH BERMS OR OTHER APPROPRIATE METHODS OF CONTAMINATION AS APPROVED BY THE CITY ENGINEER AND PROVISIONS FOR RUNOFF SHALL BE CONSTRUCTED AND MAINTAINED ALONG THE LIMITS OF DISTURBED SOIL UPON WHICH GRADING IS NOT IN PROGRESS TO PREVENT EROSION.
- 3. STORM DRAIN IMPROVEMENTS THAT ARE CONSTRUCTED AND NOT CONNECTED TO THE EXISTING SYSTEMS, INCLUDING ALL STRUCTURES AND PIPE INLETS SHALL BE PROTECTED FROM INFLOW OR SILT BY INSTALLATION OF SAND BAG SLIT BARRIERS OR OTHER MEASURES APPROVED BY THE CITY ENGINEER PER THE CONSTRUCTION DETAILS SHOWN ON THE ESC PLAN.
- 4. ADJACENT PROPERTIES WHICH ARE OR WOULD BE IMPACTED BE STORM WATER GENERATED BY THE GRADING OF THE PROJECT SHALL BE PROTECTED FROM STORM WATER, MUD, SILT, ETC. ON A DAILY BASIS.
- 5. WHERE CONSTRUCTION WILL OCCUR BETWEEN OCTOBER 1ST AND APRIL 30TH, AND OUTSIDE THAT PERIOD OF TIME WHEN RAIN IS FORECASTED, TEMPORARY EROSION AND SEDIMENTATION CONTROL AND STORM DRAIN MEASURES SHALL BE INSTALLED BY THE DEVELOPER AND/OR CONTRACTOR AND SHALL BE OPERATIONAL TO ENSURE THAT DOWNSTREAM PROPERTIES AND CITY FACILITIES WILL NOT BE IMPACTED BY STORM WATER RUN OFF OR SEDIMENTATION. THESE MEASURES MAY INCLUDE TEMPORARY RETENTION, DETENTION, OR SILTATION BASINS. THE TEMPORARY EROSION AND SEDIMENTATION CONTROL AND STORM DRAIN MEASURES SHALL BE IN PLACE BEFORE OCTOBER 1ST. THE GRADING PERMIT PERMITEE SHALL FURNISH THE DIRECTOR OF PUBLIC WORKS WITH A LETTER OF CERTIFICATION THAT ALL EROSION AND SEDIMENTATION CONTROL AND STORM DRAIN MEASURES ARE IN COMPLIANCE WITH THE GRADING ORDINANCE.
- 6. A MINIMUM OF 24 FOOT WIDTH AND 50' LENGTH OF DRAIN ROCK, 1-1/2" DIAMETER OR LARGER, AT A MINIMUM DEPTH OF 6", SHALL BE INSTALLED AT ALL UNPAVED ENTRANCES TO THE SITE. THIS DOES NOT APPLY TO ANY DRIVEWAYS CLOSED BY IMMOVABLE BARRICADES DURING CONSTRUCTION.
- 7. ALL EROSION AND SEDIMENTATION CONTROL MEASURES SHALL BE MAINTAINED UNTIL DISTURBED AREAS ARE STABILIZED. MINOR CHANGES TO THE ESC PLAN MAY BE MADE TO MEET FIELD CONDITIONS AS LONG AS THE CHANGES COMPLY WITH THE INTENT OF THE ESC PLAN.
- 8. ALL SIDEWALK AND PAVED AREAS SHALL BE KEPT CLEAR OF EARTH MATERIAL AND DEBRIS. THE SITE SHALL BE MAINTAINED SO AS TO PREVENT SEDIMENT LADEN RUNOFF FROM ENTERING ANY STORM DRAINAGE SYSTEM.
- 9. THE ESC PLAN(S) COVERS ONLY THE FIRST WINTER DURING WHICH CONSTRUCTION IS TO TAKE PLACE. THE ESC PLAN(S) ARE TO BE UPDATED, RESUBMITTED BY A QUALIFIED REPRESENTATIVE OF THE DEVELOPER, AND APPROVED PRIOR TO SEPTEMBER 1 OF EACH SUBSEQUENT YEAR UNTIL THE CITY ACCEPTS THE SITE IMPROVEMENTS.
- 10. IT IS THE RESPONSIBILITY OF THE PERMITEE TO CLEAN OUT SEDIMENT BASINS WHENEVER THE LEVEL OF SEDIMENT REACHES THE SEDIMENT CLEAN OUT LEVEL INDICATED ON THE PLANS.
- 11. IT IS THE RESPONSIBILITY OF THE PERMITEE TO PROTECT TEMPORARY BORROW AREAS AND/OR STOCKPILES WITH APPROPRIATE EROSION CONTROL MEASURES SATISFACTORY TO THE CITY ENGINEER/DIRECTOR OF PUBLIC WORKS.
- 12. THE PERMITEE SHALL CLEAN PAVED STREETS WITH MECHANICAL SWEEPERS DURING AND AT THE COMPLETION OF CONSTRUCTION. THE USE OF WATER TRUCKS TO "WASH DOWN" THE STREET IS PROHIBITED.
- 13. THE MINIMUM LEVEL OF MAINTENANCE TO BE PERFORMED IS AS FOLLOWS:
- a. IT IS THE RESPONSIBILITY OF THE PERMITEE AND/OR CONTRACTOR TO INSPECT AND REPAIR ALL EROSION CONTROL FACILITIES AT THE END OF EACH WORK DAY DURING THE RAINY SEASON.
- b. THE PERMITEE SHALL INSPECT THE EROSION AND SEDIMENTATION CONTROL MEASURES EVERY DAY OF THE STORM EVENT AND IMMEDIATELY AFTER EACH STORM EVENT. ALL REPAIRS SHALL BE MADE IMMEDIATELY WHEN THE MEASURES ARE NOT FUNCTIONING AS INTENDED. THE CONTRACTOR SHALL NOTIFY THE INSPECTOR OF ANY REPAIRS OR CORRECTIONS MADE TO THE EROSION AND SEDIMENTATION CONTROL MEASURES.
- c. SEDIMENT SHALL BE REMOVED AND SEDIMENT TRAPS RESTORED TO ORIGINAL DIMENSIONS WHEN THE SEDIMENT HAS ACCUMULATED WITHIN ONE(1) FOOT OF THE OUTLET ELEVATION.

GENERAL CIVIL NOTES

- 1. CONTRACTOR SHALL FOLLOW CITY STANDARD DETAILS AND SPECIFICATIONS FOR CONSTRUCTION.
- 2. REFER TO GEOGRAPHICAL REPORT PREPARED BY RILEY GROUP INC. UNDER PROJECT NUMBER 2018-172. DATED SEPTEMBER 17.2018.
- 3. BUILDING CONTRACTOR IS RESPONSIBLE FOR REPAIRS OF DAMAGE TO ANY EXISTING IMPROVEMENTS DURING CONSTRUCTION, SUCH AS, BUT NOT LIMITED TO DRAINAGE, UTILITIES, PAVEMENT, STRIPING, CURB, ETC. REPAIRS SHALL BE EQUAL TO OR BETTER THAN EXISTING CONDITIONS..
- 4. ADJUST PAVEMENT AND/OR CURB ELEVATIONS AS NECESSARY TO ASSURE A SMOOTH FIT & CONTINUOUS GRADE WITH EXISTING.
- 5. CONTRACTOR IS RESPONSIBLE FOR VERIFYING ALL UTILITIES AND NOTIFYING THE APPROPRIATE UTILITY COMPANY PRIOR TO BEGINNING CONSTRUCTION.
- 6. CONTRACTOR SHALL VERIFY HORIZONTAL AND VERTICAL LOCATION OF ALL EXISTING STORM DRAIN STRUCTURES, PIPES, AND ALL UTILITIES PRIOR TO CONSTRUCTION.
- 7. LOCATION AND ELEVATION OF ALL EXISTING IMPROVEMENTS WITHIN THE AREA OF WORK SHALL BE CONFIRMED BY FIELD MEASUREMENT PRIOR TO CONSTRUCTION OF NEW WORK. CONTRACTOR WILL MAKE EXPLORATORY EXCAVATIONS AND LOCATE EXISTING UNDERGROUND FACILITIES SUFFICIENTLY AHEAD OF CONSTRUCTION TO PERMIT REVISIONS TO PLANS OF REVISIONS ARE NECESSARY BECAUSE OF ACTUAL LOCATION OF EXISTING FACILITIES.
- 8. THE CONTRACTOR SHALL NOTIFY ENGINEER OF RECORD OF ANY DISCREPANCIES WITH POT-HOLED ELEVATIONS AND ELEVATIONS SHOWN ON THESE PLANS IN ADVANCE WITH ENOUGH TIME SO THAT ANY REDESIGN DOES NOT DELAY THE CONSTRUCTION SCHEDULE.
- 9. CONTRACTOR SHALL COORDINATE WITH ARCHITECTURAL PLANS, POWER COMPANY, TELEPHONE COMPANY & GAS CO. FOR ACTUAL ROUTING OF POWER AND SERVICES TO BUILDING.
- 10. FOR LOCATION OF ALL UTILITY ENTRANCES, SEE ARCHITECTURAL PLANS AND SPECIFICATIONS.
- 11. THE TOP ELEVATION OF MANHOLES CONSTRUCTED IN PAVED AREAS SHALL MATCH FINISH GRADE. THE TOP ELEVATION OF MANHOLES CONSTRUCTED IN GRASS AREA SHALL BE SIX (6") INCHES ABOVE FINISH GRADE.
- 12. CONTRACTOR SHALL CONNECT ALL PIPE ENTRANCES TO SANITARY SEWER MANHOLES TO ASSURE WATER TIGHT CONNECTIONS.
- 13. CONTRACTOR SHALL ON ALL UTILITIES, COORDINATE INSPECTION WITH APPROPRIATE AUTHORITIES PRIOR TO COVERING TRENCHES AT INSTALLATION.
- 14. CONSTRUCTION SHALL COMPLY WITH GOVERNING CODES AND REQUIREMENTS.
 CONTRACTOR SHALL CONDUCT ALL REQUIRED TESTS TO THE SATISFACTION OF THE
 UTILITY COMPANIES AND OWNERS INSPECTING AUTHORITIES.
- 15. SITE/SUBGRADE PREPARATION TO BE CONDUCTED IN ACCORDANCE WITH THE GEOTECHNICAL REPORT PREPARED BY RANEY GEOTECHNICAL INC., JOB #4647.001, DATED MAY 24, 2018


NOTES FOR UNDERGROUND FIRE PROTECTION SYSTEM

- 1. THE UNDERGROUND FIRE PROTECTION SYSTEM SHOWN ON THIS DRAWING IS SCHEMATIC AND IS NOT INTENDED TO BE AN INSTALLATION DRAWING. THIS DRAWING SHALL NOT BE USED AS A BASE SHEET FOR SHOP DRAWINGS WITHOUT WRITTEN APPROVAL OF THE PREPARER.
- 2. THE UNDERGROUND FIRE PROTECTION SYSTEM INSTALLER SHALL PREPARE SHOP DRAWINGS SHOWING ALL INFORMATION REQUIRED BY THE LOCAL FIRE MARSHAL.
- 3. SHOP DRAWINGS SHALL BE SUBMITTED TO THE LOCAL FIRE MARSHAL, THE RATING AGENCY AND THE ARCHITECT.
- 4. THE UNDERGROUND FIRE PROTECTION SYSTEM INSTALLER SHALL OBTAIN ALL APPROVALS PRIOR TO STARTING WORK.
- 5. GENERAL CONTRACTOR IS RESPONSIBLE FOR VERIFICATION OF COMPLIANCE OF THE SHOP DRAWINGS TO THE PLANS AND SPECIFICATIONS PRIOR TO SUBMITTAL.
- 6. GENERAL CONTRACTOR IS RESPONSIBLE FOR VERIFICATION OF ALL DIMENSIONS AND EQUIPMENT LOCATIONS.
- 7. PROVISIONS SHALL BE MADE IN THE SHOP DRAWINGS FOR MONITORING ALL VALVES AS REQUIRED BY THE LOCAL FIRE MARSHAL.
- 8. CONTRACTOR MUST OBTAIN PERMIT FROM THE LOCAL FIRE DEPARTMENT PRIOR TO INSTALLATION.
- 9. FIRE FLOW CALCULATIONS PROVIDED ON THIS SHEET ARE BASED ON ASSUMED FIRE SPRINKLER DESIGN.

MALCOMB EERING & SURVEYING

WARE MAL

3015 112th Avenue NE suite 205
Bellevue, Wa 98004
p 425.582.5515
waremalcomb.com

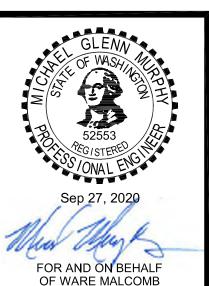

SLAMIC CENTER OF EASE SIDE 14700 MAIN STREET

NOTES


DATE

TO-17-2018 SITE SUBMITTAL

JOB NO.: SEA18-0022
PA / PM: KN / GP
DRAWN BY: SY
DATE: 10-17-2018

C1.1
Sheet 2 of 11

Know what's below.
Call 811 before you dig.

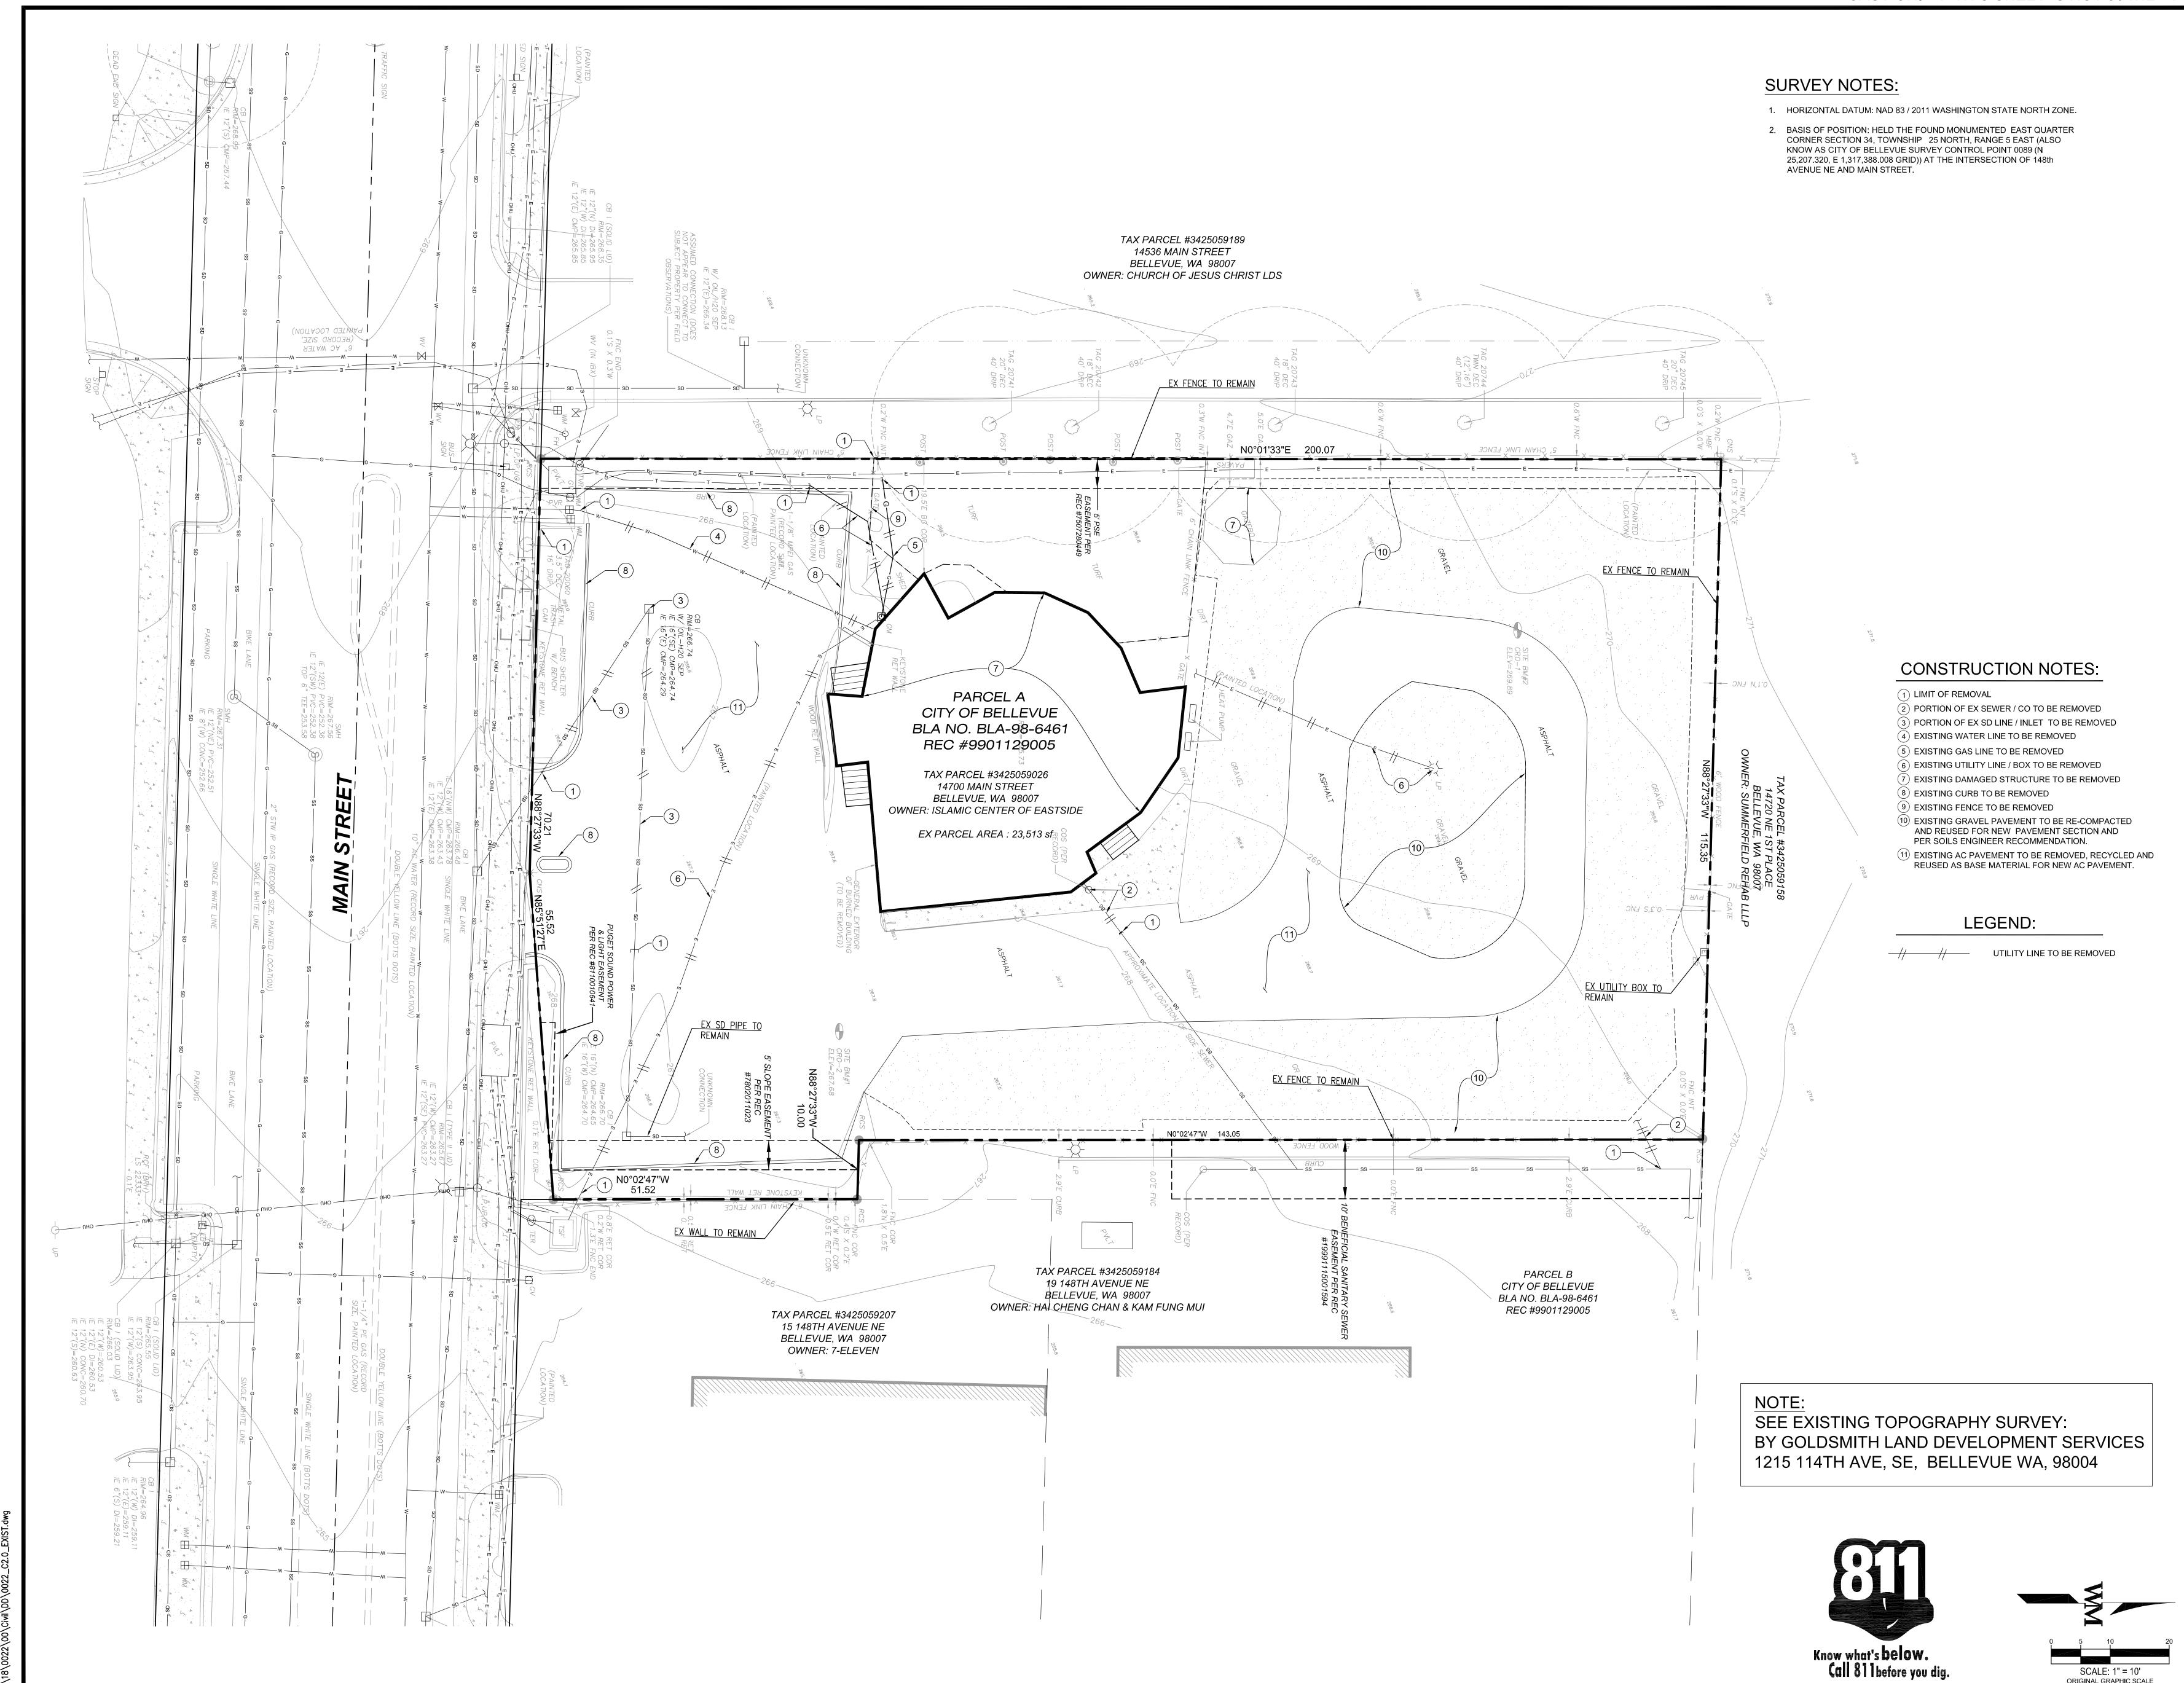

FOR AND ON BEHALF OF WARE MALCOMB

EASE | REET | 98007

DRAWN BY:

Sheet 3 of 11

SCALE: 1" = 10' ORIGINAL GRAPHIC SCALE

SCALE: 1" = 10' ORIGINAL GRAPHIC SCALE

FOR AND ON BEHALF OF WARE MALCOMB

EASE REET 98007


JOB NO.: KN/GP DRAWN BY:

Know what's **below.** Call 811 before you dig.

WARE MALCOMB
CIVIL ENGINEERING & SURVEYING

EASE REET 98007

JOB NO.: SEA18-0022 KN / GP PA / PM: DRAWN BY: DATE: 10-17-2018

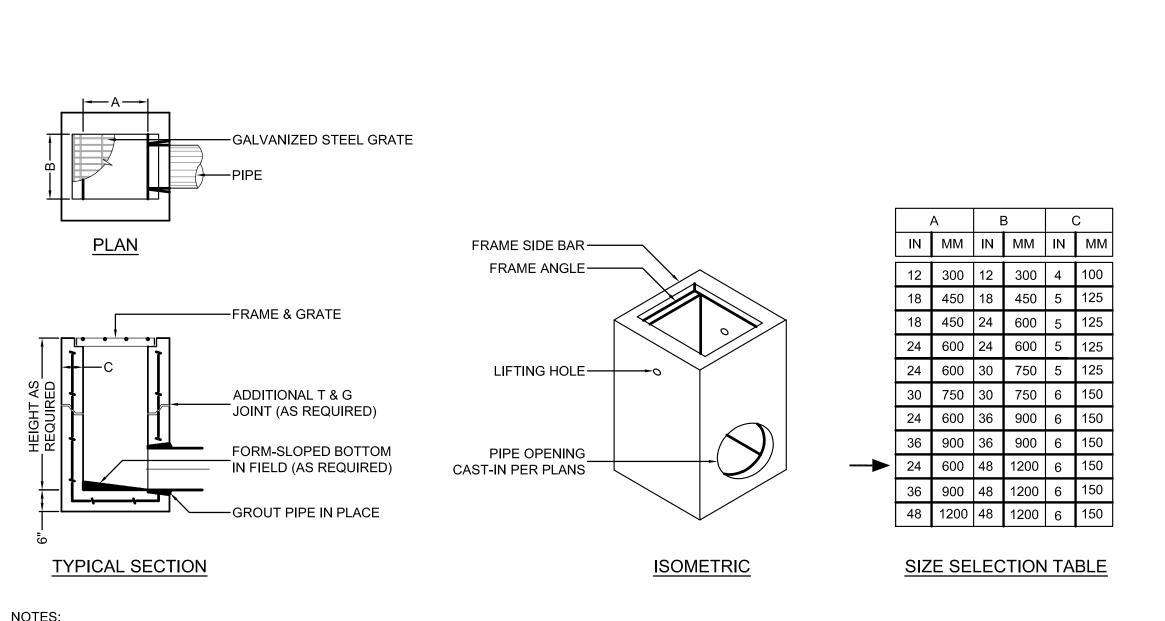

FIRE DEPARTMENT ASSEMBLY

SCALE: N.T.S.

1. SEE GUTTER FLARE DETAIL __ SHEET C3.1

SQUARE INLETS & DRAINS

POST INDICATOR VALVE ASSEMBLY W/ TAMPER

2 1/2" X 2 1/2" FIRE DEPT. SIAMESE CONNECTION

W/ BREAK AWAY CAPS. EXTRA IN HEAD CABINET.

(SET FDC INLET 30-36" ABOVE FINISH GRADE)


SWITCH (SET TOP OF PIV 36" ABOVE FINISH-

GRADE). PER CITY BELLEVUE STD.

PER CITY OF BELLEVUE STANDARDŚ

SERVICE J MAIN LOOP

SCALE: N.T.S.

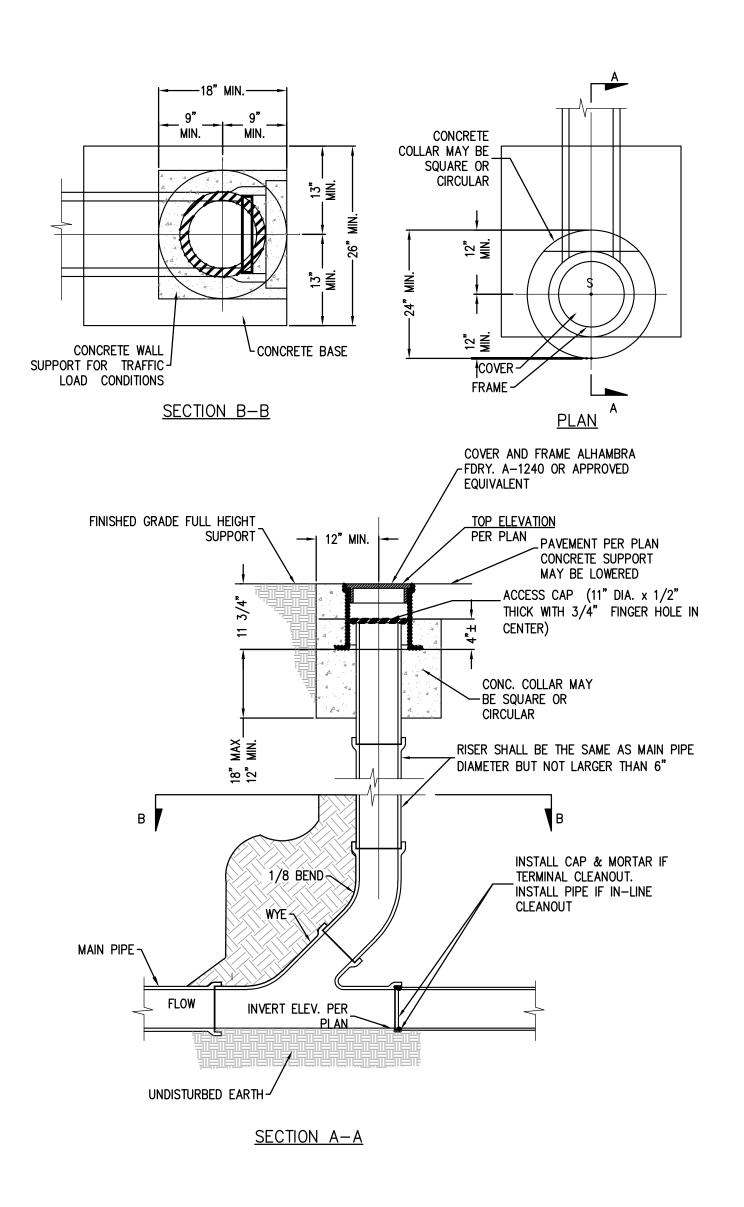


<u>NOTES:</u> SEE PROJECT PLANS FOR INVERT ELEVATION. 2. PIPE AND FITTINGS, EXCEPT AS OTHERWISE SHOWN ON HEREON, SHALL BE OF THE SAME MATERIAL AS THE SEWER.


PIPES AND FITTINGS SHALL BE PROPERLY ALIGNED AND MAINTAINED WHILE CONCRETE IS BEING PLACED AND ALLOWED TO HARDEN. JOINTS FOR PIPES AND FITTINGS SHALL BE MADE PRIOR TO PLACING CONCRETE. CONCRETE FOR BEDDING, ENCASEMENT, AND WALL SUPPORT FOR PIPES AND FITTINGS SHALL BE PLACED UNIFORMLY AROUND THE PIPE AND FITTINGS AS SHOWN HEREON TO MAINTAIN PROPER ALIGNMENT, AND SHALL BE CLASS 420-C-2000. THE ACCESS FRAME, COVER AND CAP SHALL BE CAST IRON. THE FINGER HOLES MAY BE DRILLED OUT OR MAY BE BLOCKED OUT

PRIOR TO CASTING; THEY SHALL NOT BE PUNCHED OUT. 5. THE CONTRACTOR, AT HIS OPTION, MAY PLACE EITHER CIRCULAR OR SQUARE CONCRETE PIPE WALL SUPPORTS AS SHOWN HEREON.

STANDARD CLEAN OUT (PRIVATE) SC6 D


SCALE: N.T.S.

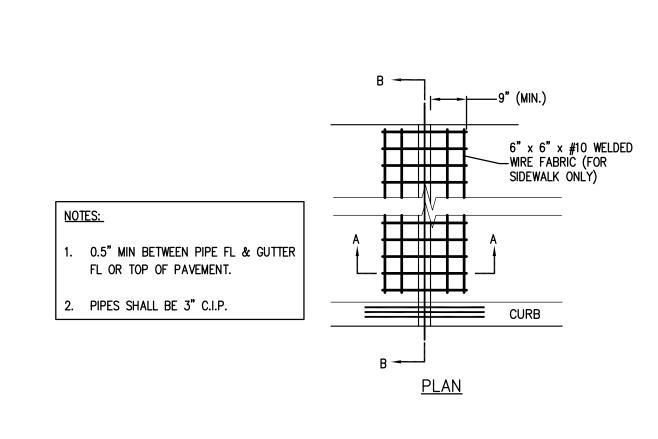

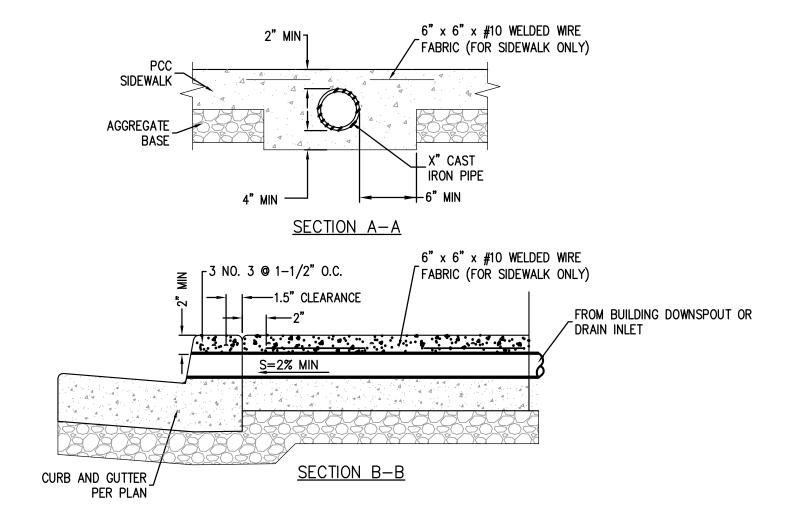


THROUGH CURB DRAIN _____E SCALE: N.T.S.



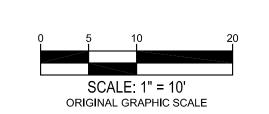


WARE MALCOMB
CIVIL ENGINEERING & SURVEYING

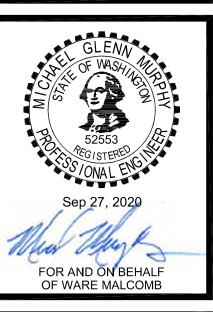



EASE


JOB NO.: DRAWN BY: DATE: 10-17-2018


Sheet 6 of 11

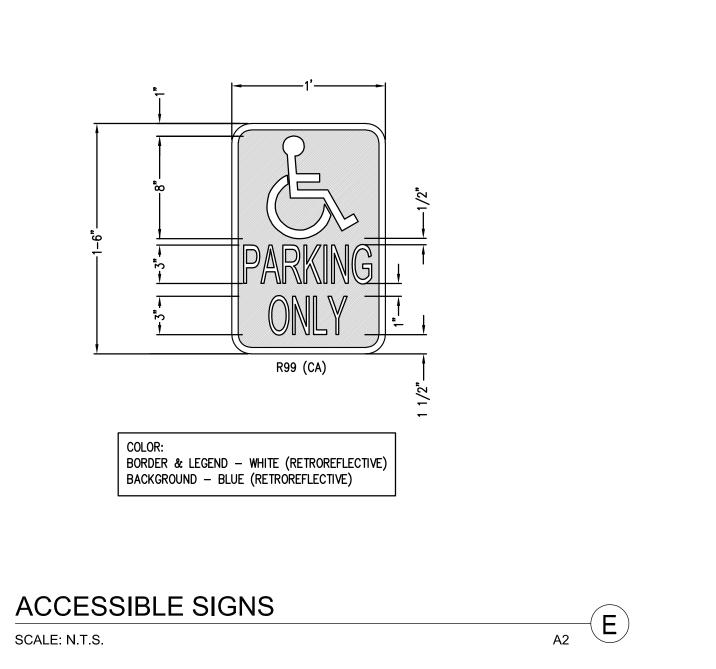


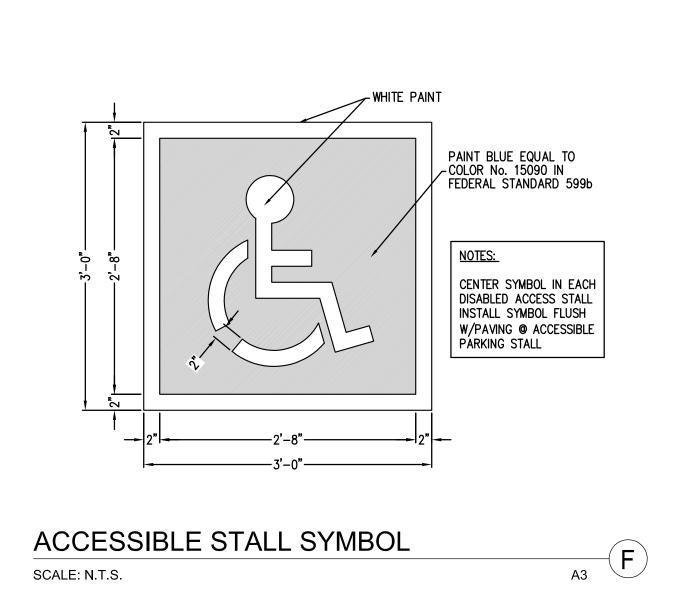


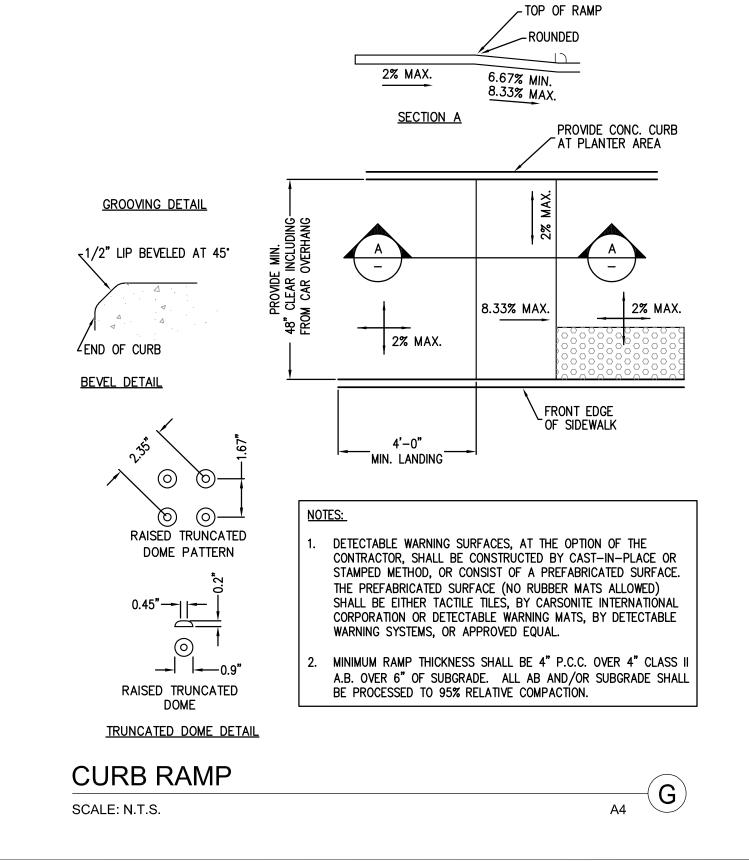


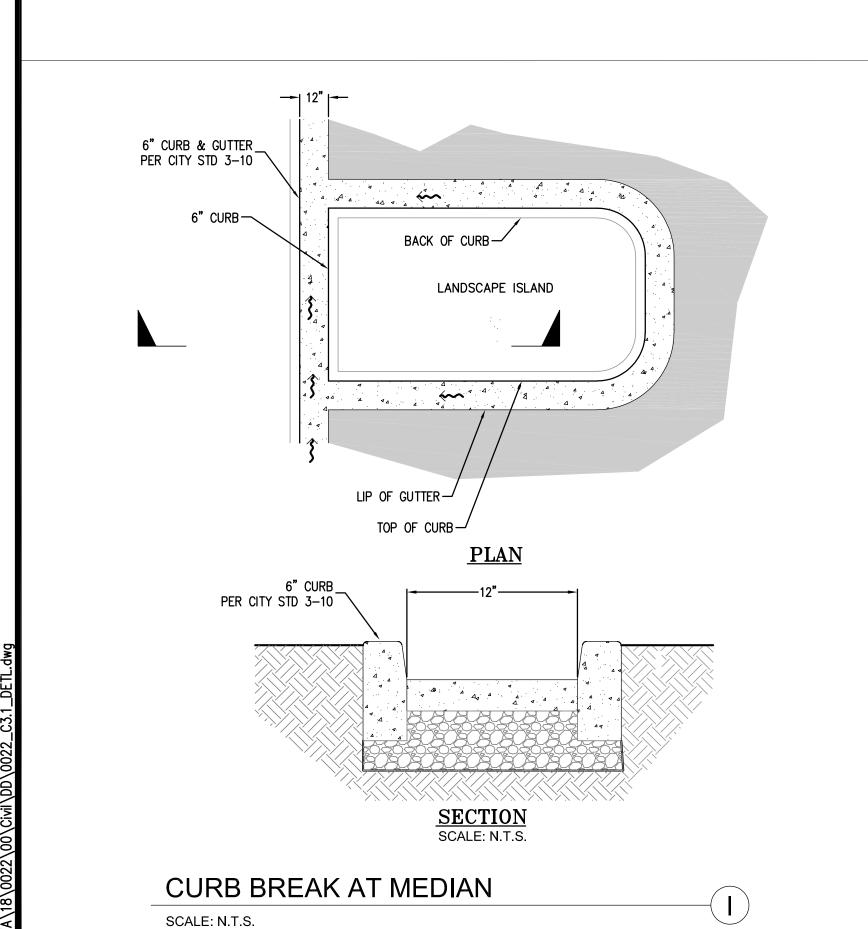

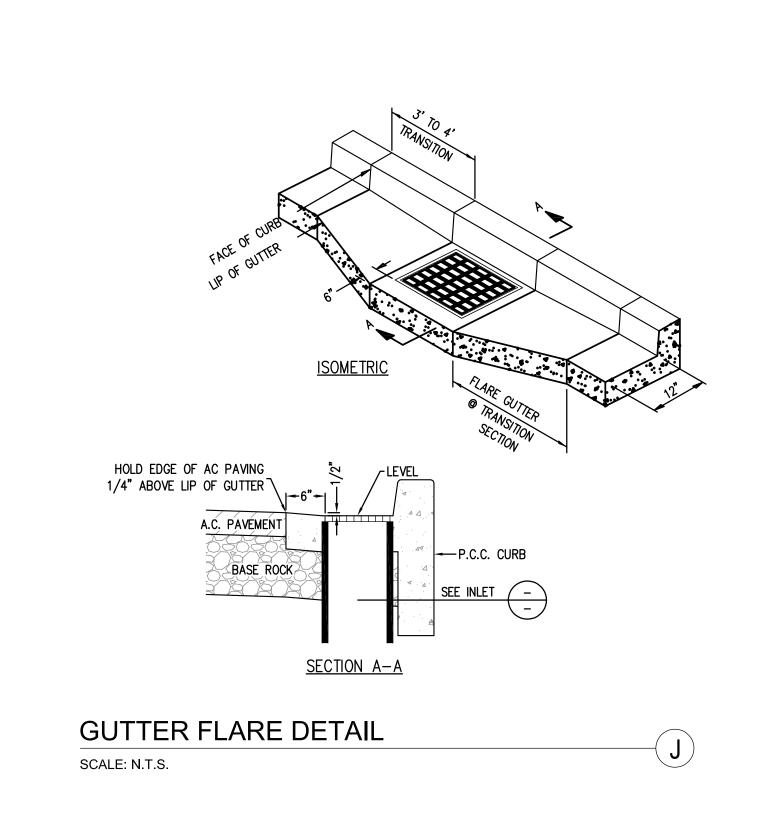

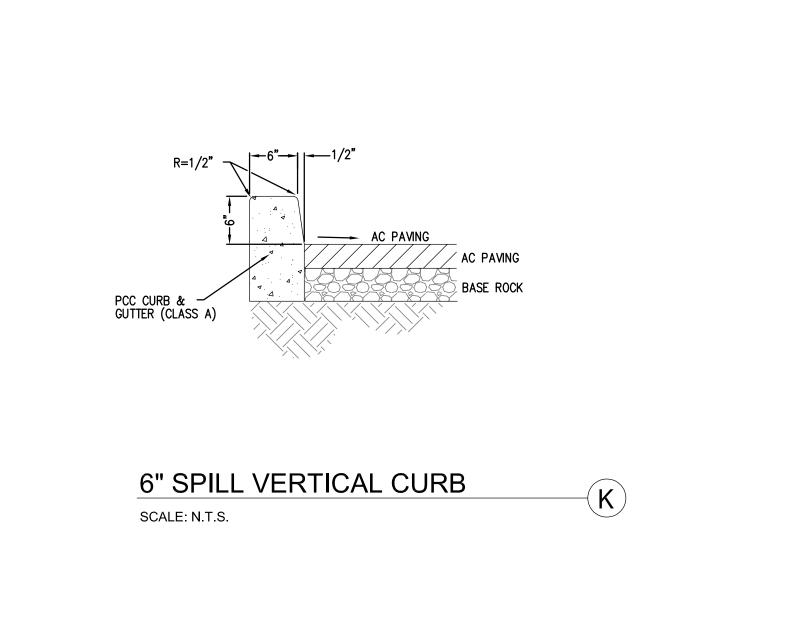

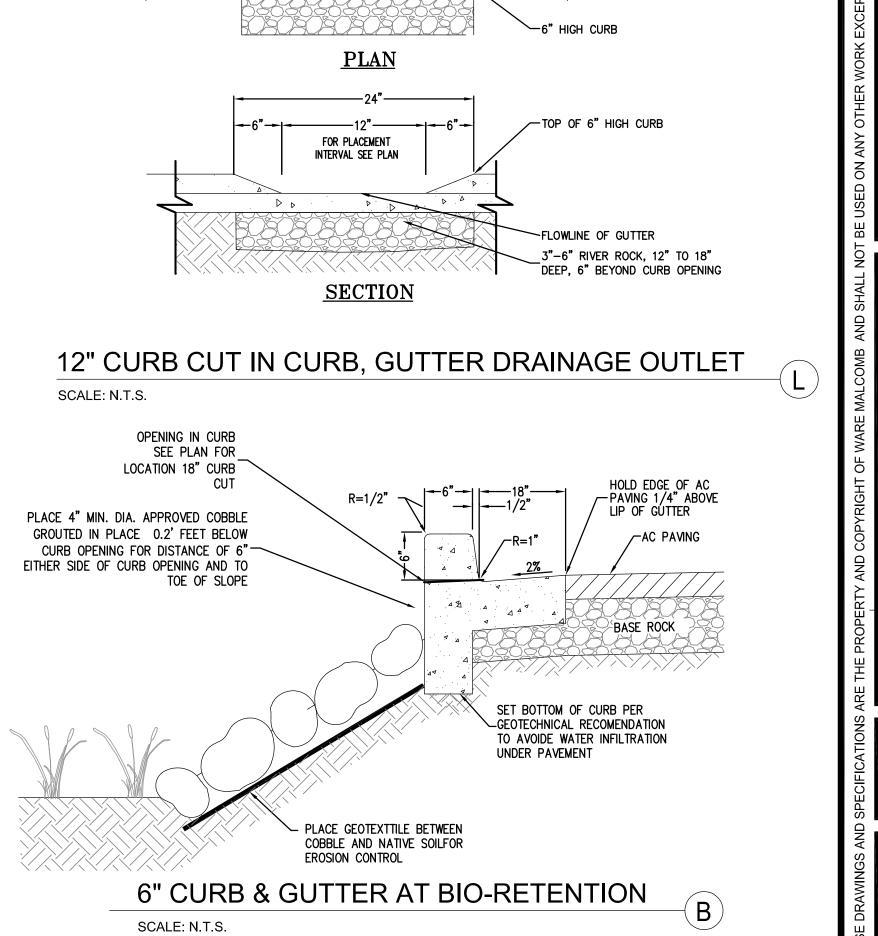

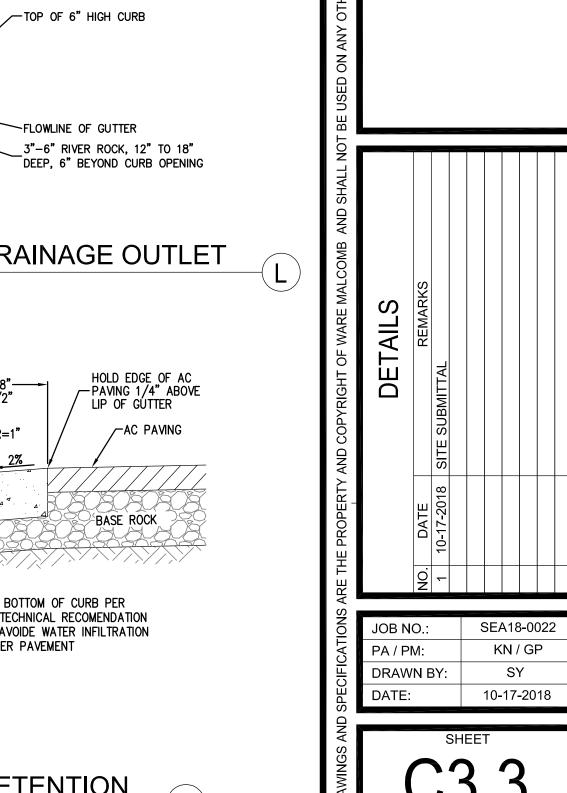



FOR AND ON BEHALF OF WARE MALCOMB

EASE FREET 98007

2" DOMESTIC WATER FIRE SERVICE LINE WITH DDCV, PIV AND FDC BY OTHERS

24" DRAIN BOX OLDCASTLE U21 OR APPROVED EQUAL. SEE DETAIL ON

ADJUST AND FLUSH RIM WITH NEW FG , INSTALL COBBLE STONE RIP-RAP AS SHOWN ON PLANS

CONSTRUCTION **NOTES**

INSTALL SSCO ON TOP OF EXIST. SS PIPE CONTRACTOR TO VERIFY LOCATION AND DEPTH PRIOR TO CONSTRUCTION EX WATER METER TO REMAIN, UPSIZE METER TO 2" AND BY THE CITY RECOMMENDATIONS, CONNECTION TO NEW BUILDING BY PLUMBING


APPROX. LOCATION OF SERVICE UTILITIES, GAS & TEL. BY OTHERS


CONCTACTOR

SDCO SEE DETAIL SHEET C3.2 ON SHEET C3.2


SUB-IRRIGATION METER AND BACKFLOW PREVENTER, IRRIGATION PLANS BY OTHERS

KN / GP DRAWN BY:

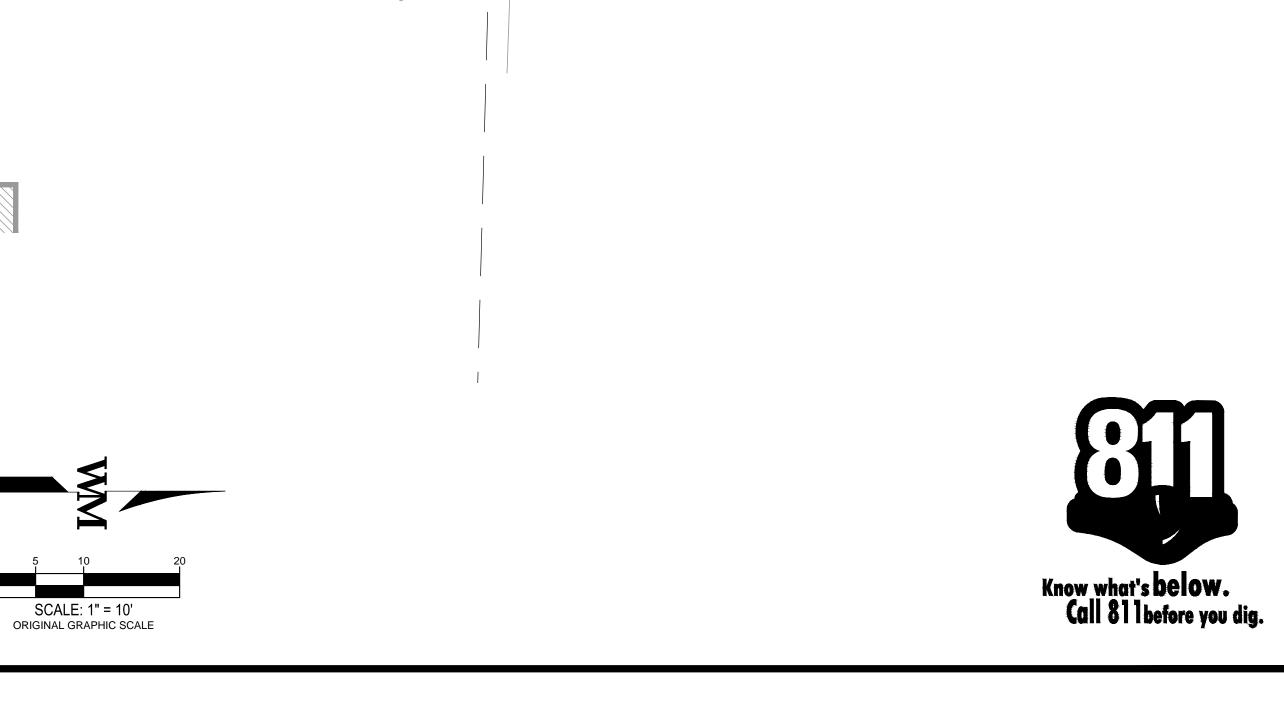

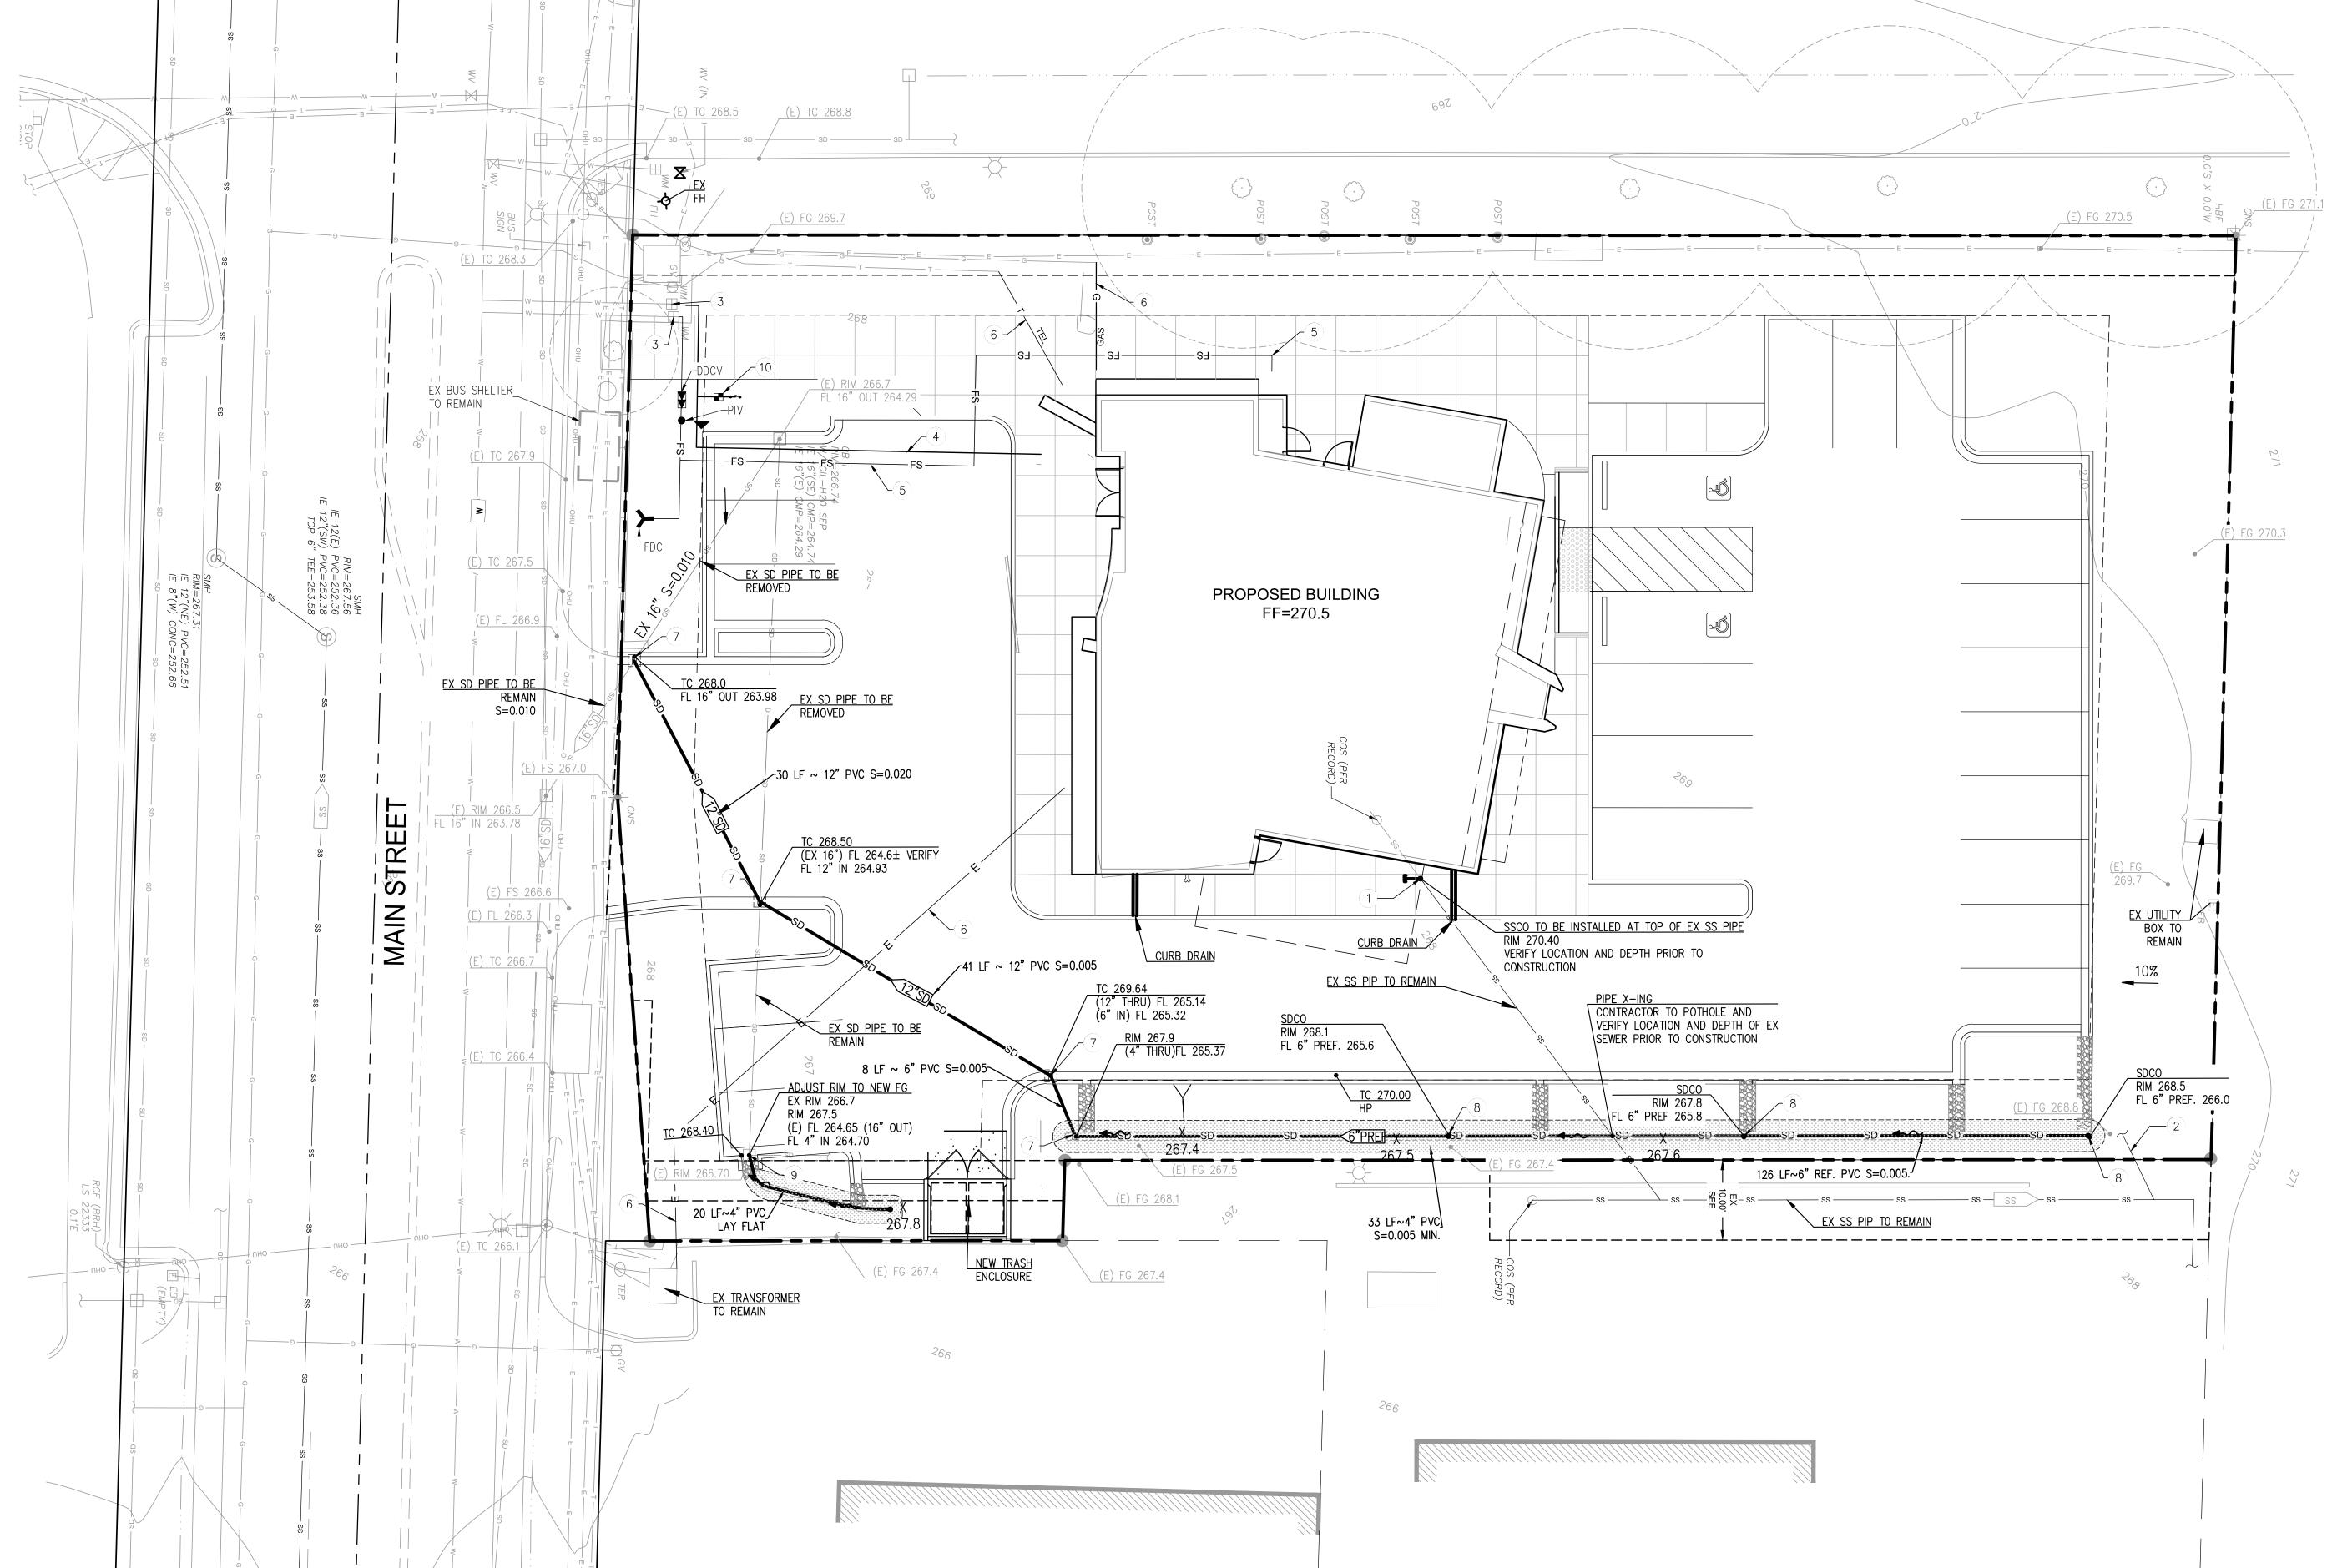

UTILITY PLAN
SCALE: 1" = 10'

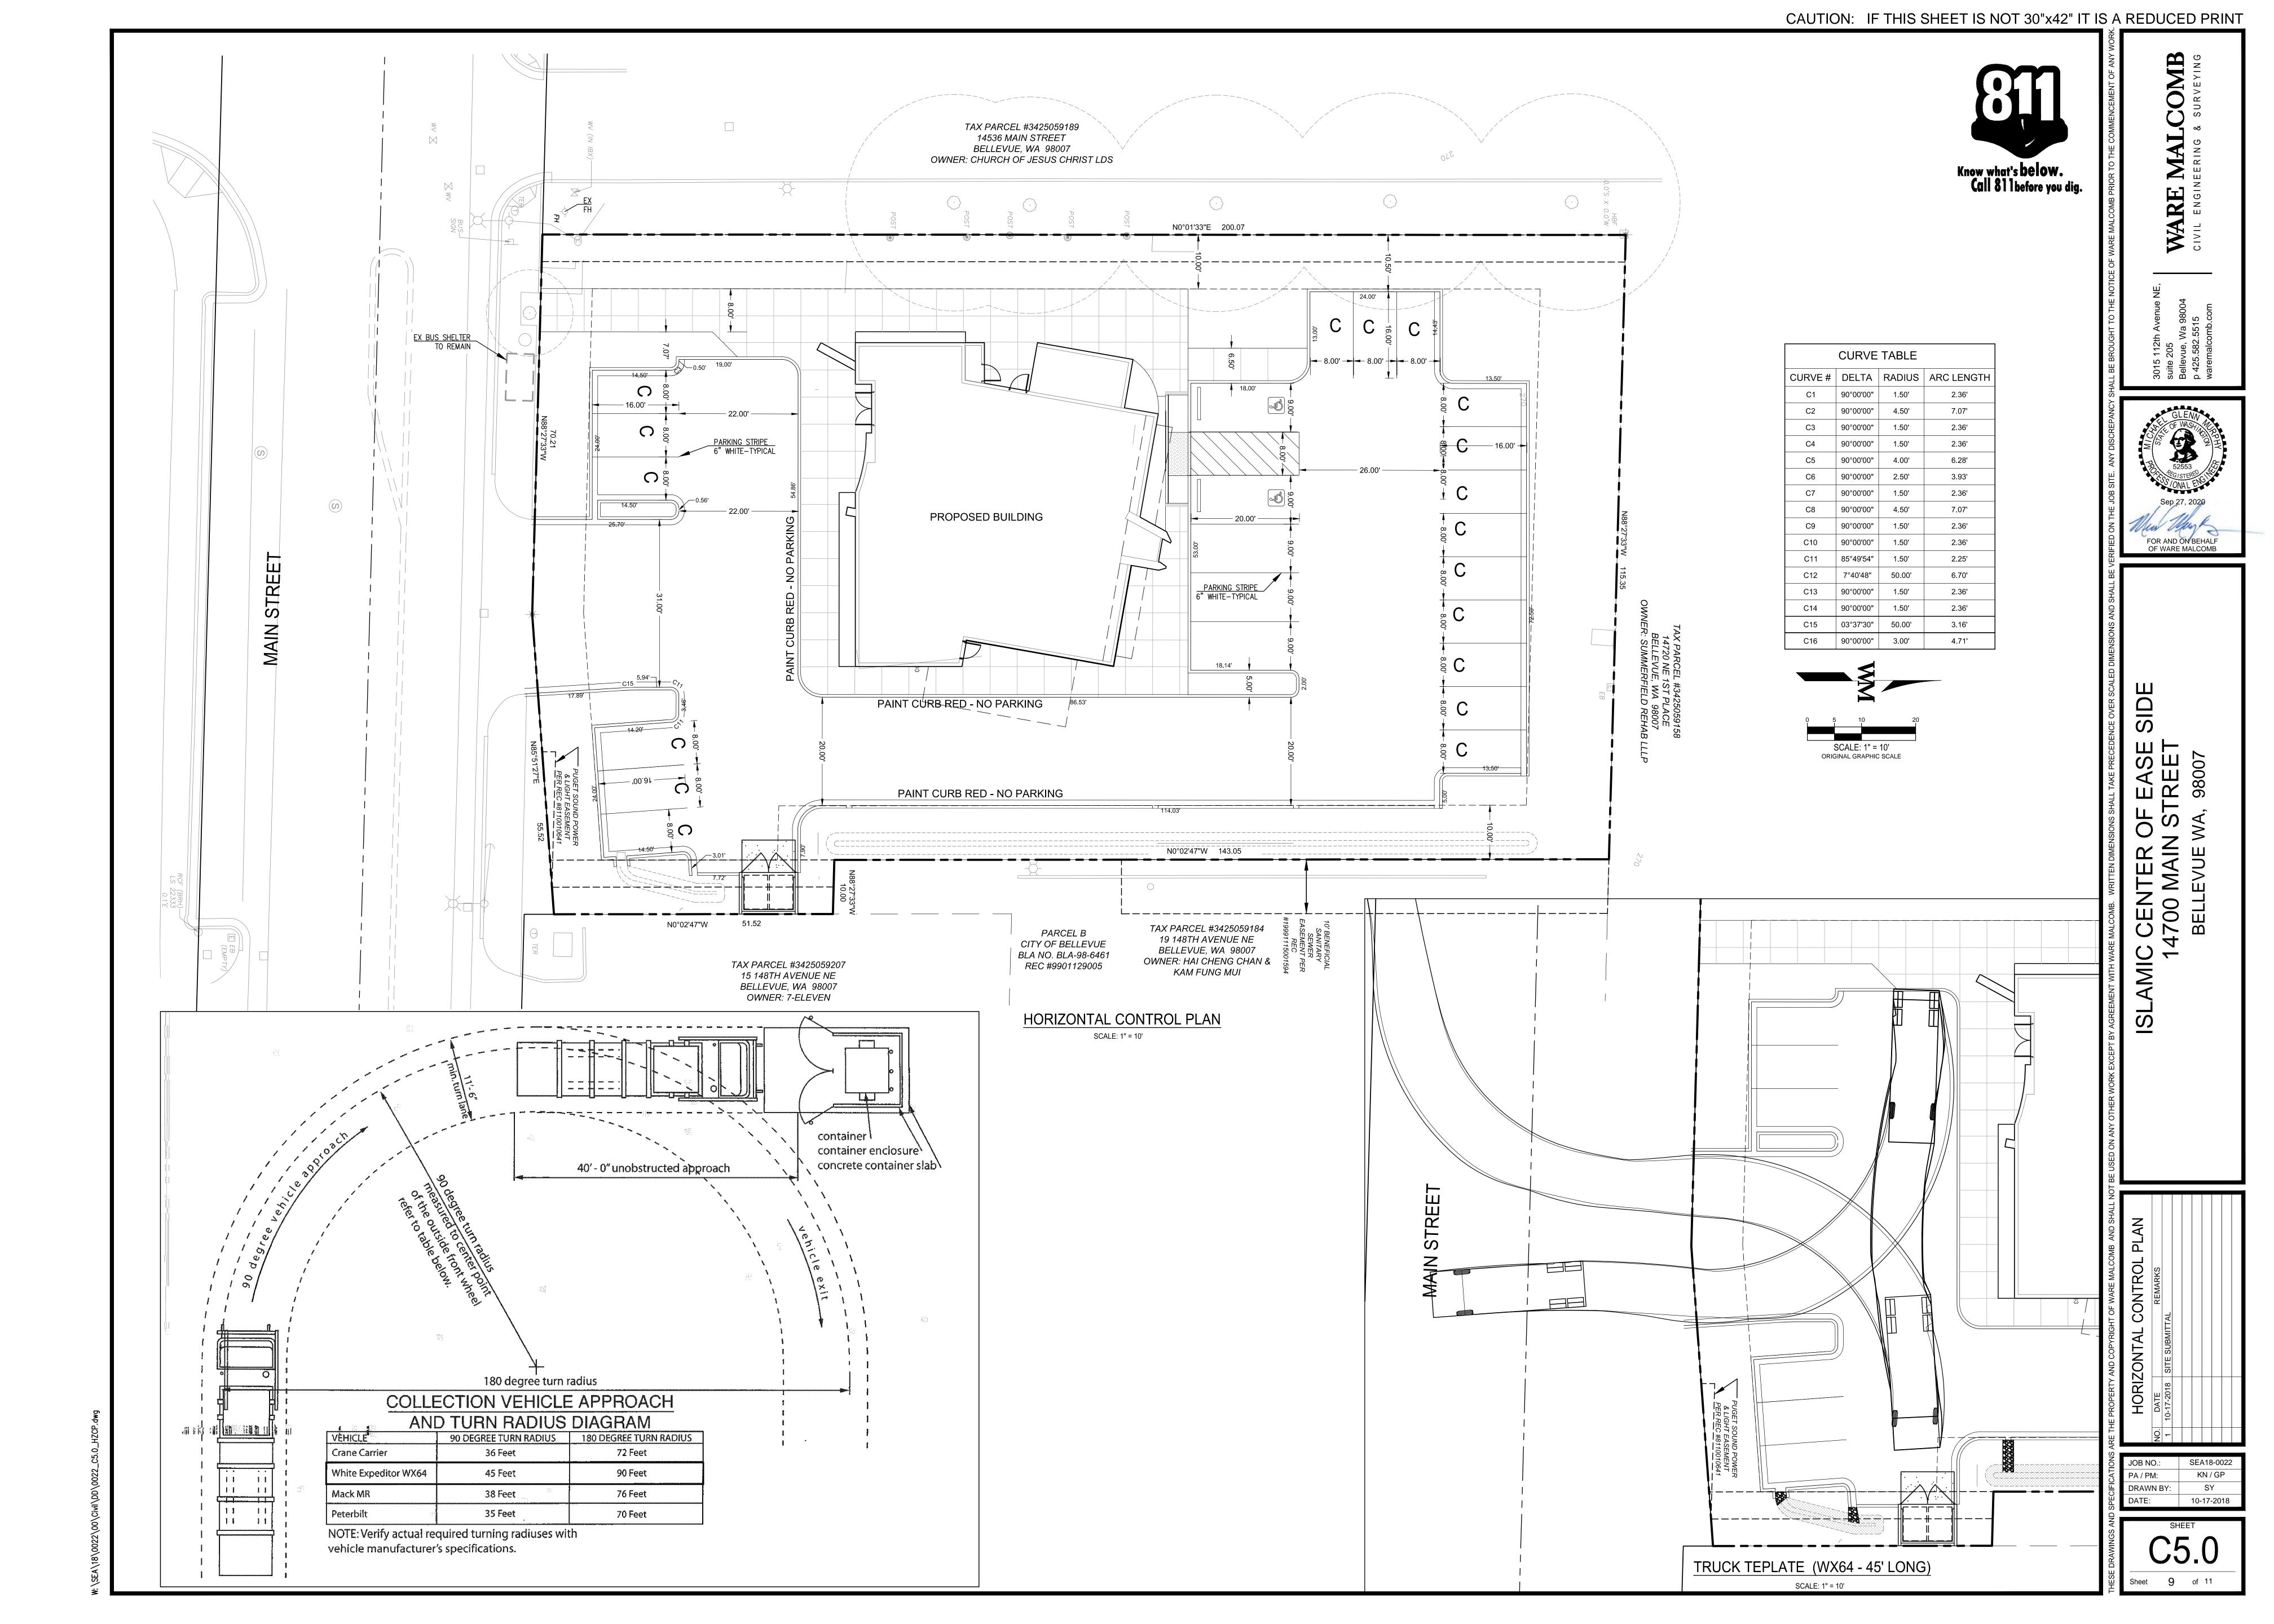

SCALE: 1" = 10' ORIGINAL GRAPHIC SCALE



EROSION & SEDIMENT CONTROL NOTES

1. CONTRACTOR: XXXX XXXX (925) XXXX

- 2. IT SHALL BE THE OWNER'S RESPONSIBILITY TO MAINTAIN CONTROL OF THE ENTIRE CONSTRUCTION OPERATION AND TO KEEP THE SITE IN COMPLIANCE WITH THE SOIL EROSION CONTROL PLAN.
- 3. CIVIL ENGINEER: WARE MALCOMB MICHAEL MURPHY

(925) 480-6083

4. CONSTRUCTION SUPERINTENDENT: XXXX XXXX

(925) XX

5. THIS PLAN IS INTENDED TO BE USED FOR INTERIM EROSION AND SEDIMENT CONTROL ONLY AND IS

NOT TO BE USED FOR FINAL ELEVATIONS OR PERMANENT IMPROVEMENTS.

6. THE DEVELOPER IS RESPONSIBLE FOR ENSURING THAT ALL CONTRACTORS AND SUBCONTRACTORS ARE AWARE OF ALL STORM WATER QUALITY MEASURES AND IMPLEMENT SUCH MEASURES. FAILURE TO COMPLY WITH THE APPROVED CONSTRUCTION BEST MANAGEMENT PRACTICES WILL RESULT IN THE ISSUANCE OF CORRECTION NOTICES, CITATIONS, AND/OR STOP ORDERS.

7. THIS PLAN COVERS ONLY THE FIRST WINTER FOLLOWING GRADING WITH ASSUMED SITE CONDITIONS AS SHOWN ON THE EROSION CONTROL PLAN. PRIOR TO SEPTEMBER 15, THE COMPLETION OF SITE IMPROVEMENTS SHALL BE EVALAUATED AND REVISIONS BE MADE TO THIS PLAN AS NECESSARY WITH THE APPROVAL OF THE CITY ENGINEER. PLANS ARE TO BE SUBMITTED FOR CITY APPROVAL PRIOR TO SEPTEMBER 1 OF EACH SUBSEQUENT YEAR UNTIL SITE IMPROVEMENTS ARE ACCEPTED BY THE CITY.

8. ANY VEHICLE OR EQUIPMENT WASHING/STEAM CLEANING MUST BE DONE AT AN APPROPRIATELY EQUIPPED FACILITY WHICH DRAINS TO THE SANITARY SEWER. OUTDOOR WASHING MUST BE MANAGED IN SUCH A WAY THAT THERE IS NO DISCHARGE OF SOAPS, SOLVENTS, CLEANING AGENTS OR OTHER POLLUTANTS TO THE STORM DRAINS. WASH WATER SHALL DISCHARGE TO THE SANITARY SEWER, SUBJECT TO REVIEW AND APPROVAL OF UNION SANITARY DISTRICT.

9. THE CONTRACTOR SHALL BE RESPONSIBLE FOR LITTER CONTROL AND SWEEPING OF ALL PAVED SURFACES DURING CONSTRUCTION.

10. THE FACILITIES SHOWN ON THIS PLAN ARE DESIGNED TO CONTROL EROSION AND SEDIMENT DURING THE RAINY SEASON, OCTOBER 1 TO APRIL 15. GRADING OPERATIONS DURING THE RAINY SEASON WHICH LEAVE DENUDED SLOPES SHALL BE PROTECTED WITH EROSION CONTROL MEASURES IMMEDIATELY FOLLOWING GRADING ON THE SLOPES. DURING THE NON-RAINY SEASON, BEST MANAGEMENT PRACTICES (BMP'S) MUST BE IMPLEMENTED DURING CONSTRUCTION WHICH INCLUDES BUT IS NOT LIMITED TO: STABILZED CONSTRUCTION ENTRANCE(S), TIRE WASH AREA AND INLET PROTECTION.

11. OWNER/CONTRACTOR SHALL BE RESPONSIBLE FOR MONITORING EROSION AND SEDIMENT CONTROL MEASURES PRIOR TO, DURING AND AFTER STORM EVENTS.

12. ALL ON-SITE STORM DRAINS SHALL BE CLEANED IMMEDIATELY BEFORE THE START OF THE RAINY SEASON BEGINNING ON OCTOBER 1ST OF EACH YEAR, SUBJECT TO THE REVIEW OF THE BUILDING/ENGINEERING INSPECTOR.

13. IF RAINY WEATHER BECOMES IMMINENT, GRADING OPERATIONS SHALL BE STOPPED AND EROSION CONTROL MEASURES SHALL BE IMPLEMENTED TO PROTECT DISTURBED AREAS.

14. DURING THE RAINY SEASON, ALL PAVED AREAS SHALL BE KEPT CLEAR OF EARTH MATERIAL AND DEBRIS. THE SITE SHALL BE MAINTAINED SO AS TO MINIMIZE SEDIMENT LADEN RUNOFF TO ANY STORM DRAIN SYSTEM.

15. CONSTRUCTION ENTRANCES SHALL BE INSTALLED PRIOR TO COMMENCEMENT OF GRADING. ALL CONSTRUCTION TRAFFIC ENTERING ONTO PAVED ROADS MUST CROSS THE STABILZED CONSTRUCTION ENTRANCE(S). ANY MUD OR DEBRIS OR DEBRIS TRACKED ONTO PUBLIC STREETS SHALL BE REMOVED DAILY AND AS REQUIRED BY THE CITY.

16. INLET PROTECTION SHALL BE INSTALLED AT OPEN INLETS TO PREVENT SEDIMENT FROM ENTERING THE STORM DRAIN SYSTEM. INLETS NOT USED IN CONJUNCTION WITH EROSION CONTROL MEASURES ARE TO BE BLOCKED UNLESS THE AREA DRAIN IS UNDISTURBED OR STABILIZED.

17. BORROW AREAS AND TEMPORARY STOCKPILES SHALL BE PROTECTED WITH APPROPRIATE EROSION CONTORL MEASURES TO THE SATISFACTION OF THE CITY ENGINEER.

18. ALL DISTURBED AREAS INCLUDING FLAT PADS ARE TO BE TREATED WITH STRAW AND TACKIFIER AT A RATE OF 2 TONS PER ACRE APPROXIMATELY 3 INCHES THICK.

19. THIS EROSION AND SEDIMENT CONTROL PLAN MAY NOT COVER ALL SITUATIONS THAT MAY ARISE DURING CONSTRUCTION DUE TO UNANTICIPATED FIELD CONDITIONS. VARIATIONS AND ADDITIONS MAY BE MADE TO THIS PLAN IN THE FIELD. NOTIFY CITY PROJECT INSPECTOR OF ANY FIELD CHANGES.


20. KEEP CONSTRUCTION TRAFFIC OUT OF STORMWATER TREATMENT AREA LOCATIONS, AND MINIMIZE COMPACTION OF EXISTING SOILS.


21. PROTECT STORMWATER TREATMENT FACILITIES FROM CONSTRUCTION SITE RUNOFF. ONCE IMPORTED MATERIALS ARE INSTALLED IN STORMWATER TREATMENT FACILITIES, RUNOFF FROM UNSTABILIZED AREAS MUST BE DIVERTED AWAY FROM SUCH FACILITIES.

22. THE COSTRUCTION BMPs SHOWN ON THE PLAN ARE MINIMUM REQUIREMENTS. THE CITY ENGINEER OR STORMWATER INSPECTOR IS AUTHORIZED TO REQUIRE ADDITIONAL BMPs TO PREVENT NON-STORMWATER DISCHARGES.

EROSION CONTROL NOTES

- A. GRADING PLANS SHALL BE DESIGNED WITH LONG-TERM EROSION AND SEDIMENT CONTROL AS A PRIMARY CONSIDERATION.
- B. NO GRADING OPERATIONS SHALL BE CONDUCTED DURING THE RAINY SEASON EXCEPT UPON A CLEAR DEMONSTRATION, TO THE SATISFACTION OF THE DIRECTOR OF PUBLIC WORKS, THAT AT NO STAGE OF THE WORK WILL THERE BE ANY SUBSTANTIAL RISK OF INCREASED SEDIMENT DISCHARGE FROM THE SITE.
- C. SHOULD GRADING BE PERMITTED DURING THE RAINY SEASON, THE SMALLEST PRACTICABLE AREA OF ERODIBLE LAND SHALL BE EXPOSED AT ANY ONE TIME DURING GRADING OPERATIONS AND THE TIME OF EXPOSURE SHALL BE MINIMIZED.
- D. NATURAL FEATURES, INCLUDING VEGETATION, TERRAIN, WATERCOURSES AND SIMILAR RESOURCES SHALL BE PRESERVED WHEREVER POSSIBLE. LIMITS OF GRADING SHALL BE CLEARLY DEFINED AND MARKED TO PREVENT DAMAGE BY CONSTRUCTION EQUIPMENT.
- E. PERMANENT VEGETATION AND STRUCTURES FOR EROSION AND SEDIMENT CONTROL SHALL BE INSTALLED AS SOON AS POSSIBLE.
- F. ADEQUATE PROVISION SHALL BE MADE FOR LONG-TERM MAINTENANCE OF PERMANENT EROSION AND SEDIMENT CONTROL STRUCTURES AND VEGETATION.
- G. NO TOPSOIL SHALL BE REMOVED FROM THE SITE UNLESS OTHERWISE DIRECTED OR APPROVED BY THE DIRECTOR OF PUBLIC WORKS. TOPSOIL OVERBURDEN SHALL BE STOCKPILED AND REDISTRIBUTED WITHIN THE GRADED AREA AFTER ROUGH GRADING TO PROVIDE A SUITABLE BASE FOR SEEDING AND PLANTING. RUNOFF FROM THE STOCKPILED AREA SHALL BE CONTROLLED TO PREVENT EROSION AND RESULTANT SEDIMENTATION OF RECEIVING WATER.
- H. RUNOFF SHALL NOT BE DISCHARGED FROM THE SITE IN QUANTITIES OR AT VELOCITIES SUBSTANTIALLY ABOVE THOSE WHICH OCCURRED BEFORE GRADING EXCEPT INTO DRAINAGE FACILITIES WHOSE DESIGN HAS BEEN SPECIFICALLY APPROVED BY THE DIRECTOR OF PUBLIC WORKS
- I. PERMITTEE SHALL TAKE REASONABLE PRECAUTIONS TO ENSURE THAT VEHICLES DO NOT TRACK OR SPILL EARTH MATERIALS INTO PUBLIC STREETS AND SHALL IMMEDIATELY REMOVE SUCH MATERIALS IF THIS OCCURS

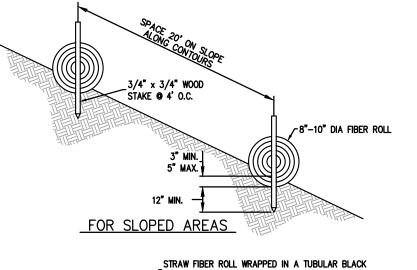

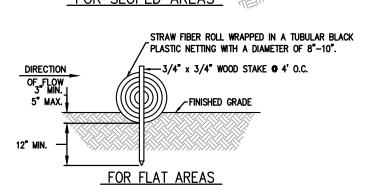


NOTES:

1. FIBER ROLL COMPOSED OF BIO-DEGRADEABLE FIBERS STUFFED INTO A PHOTO-DEGRADEABLE OPEN WEAVE NETTING.


2. FIBER ROLL EROSION BARRIER TRAPS SEDIMENT AND REDUCES SHEET AND HILL SIDE EROSION BY REDUCING SLOPE GRADIENT. IT INCREASING INFILTRATION RATES AND BY PRODUCING A FAVORABLE ENVIRONMENT FOR PLANT ESTABLISHMENT.

3. FIBER ROLL INSTALLATION REQUIRES THE PLACEMENT AND SECURE STAKING OF THE FIBER ROLL IN A TRENCH 3"-5" DEEP, DUG ON CONTOUR. RUNOFF MUST NOT BE ALLOWED TO RUN UNDER OR AROUND FIBER ROLL.




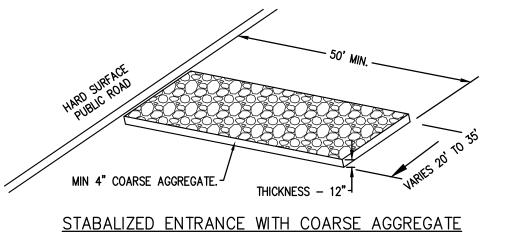

STABILIZED ENTRANCE/EXIT DETAIL
SCALE: N.T.S. E8

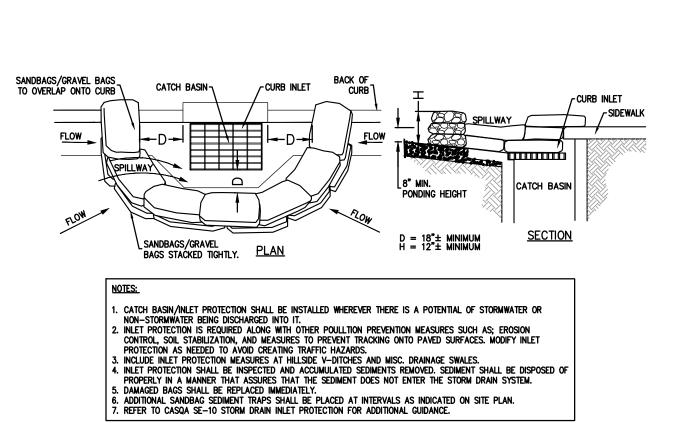



CATCH BASIN/DRAIN INLET PROTECTION

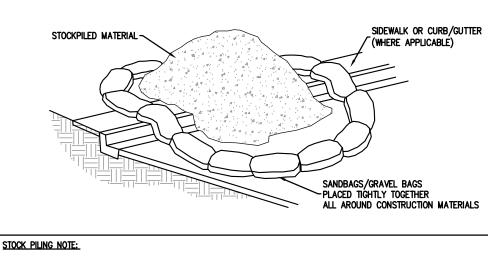

DIRT AND OTHER CONSTRUCTION RELATED MATERIALS PLACED IN THE STREET OR ON OTHER IMPERVIOUS SURFACES MUST BE CONTAINED WITH SANDBAGS OR OTHER MEASURES TO PREVENT TRANSPORT TO THE STORM DRAIN SYSTEM.ANY CONSTRUCTION MATERIAL STORED OR STOCKPILED ON—SITE SHALL BE PROTECTED FROM BEING TRANSPORTED BY THE FORCE OF WIND OR WATER. COVER MATERIAL WITH PLASTIC SHEETS (MIN. 10 MIL.) WITH SAND BAGS FOR ANCHORING.


2. REFER TO CASQA WM—3 STOCKPILE MANAGEMENT FOR ADDITIONAL GUIDANCE.

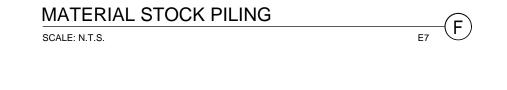

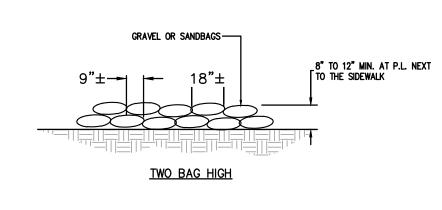


TYPICAL GRAVEL BAGGING DETAILS

SCALE: N.T.S. E5

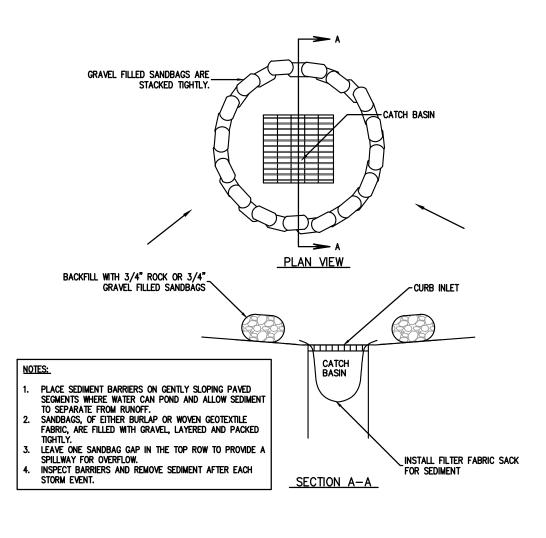

INLET SEDIMENT BARRIER


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WARE MALCOMB

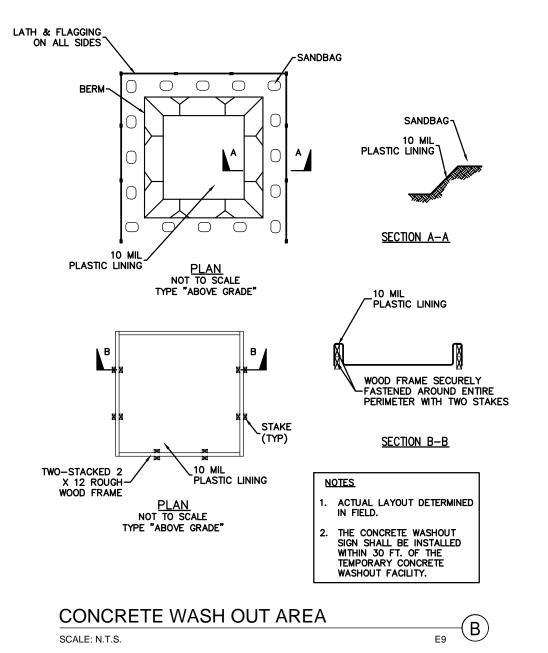3015 112th Avenue NE, suite 205 Bellevue, Wa 98004 p 425.582.5515 waremalcomb.com



SLAMIC CENTER OF EASE SIE 14700 MAIN STREET

HE PROPERTY AND COPYRIGHT OF WARE MALCOMB AND SHALL NOT ESOSION CONTROL

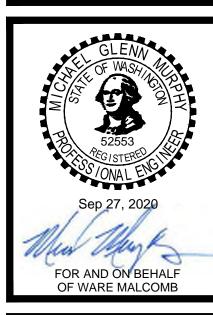NOTES AND DETAILS

DATE


REMARKS

10-17-2018 SITE SUBMITTAL

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PA / PM: KN / GP
DRAWN BY: SY
DATE: 10-17-2018


C6.1

Sheet 11 of 11

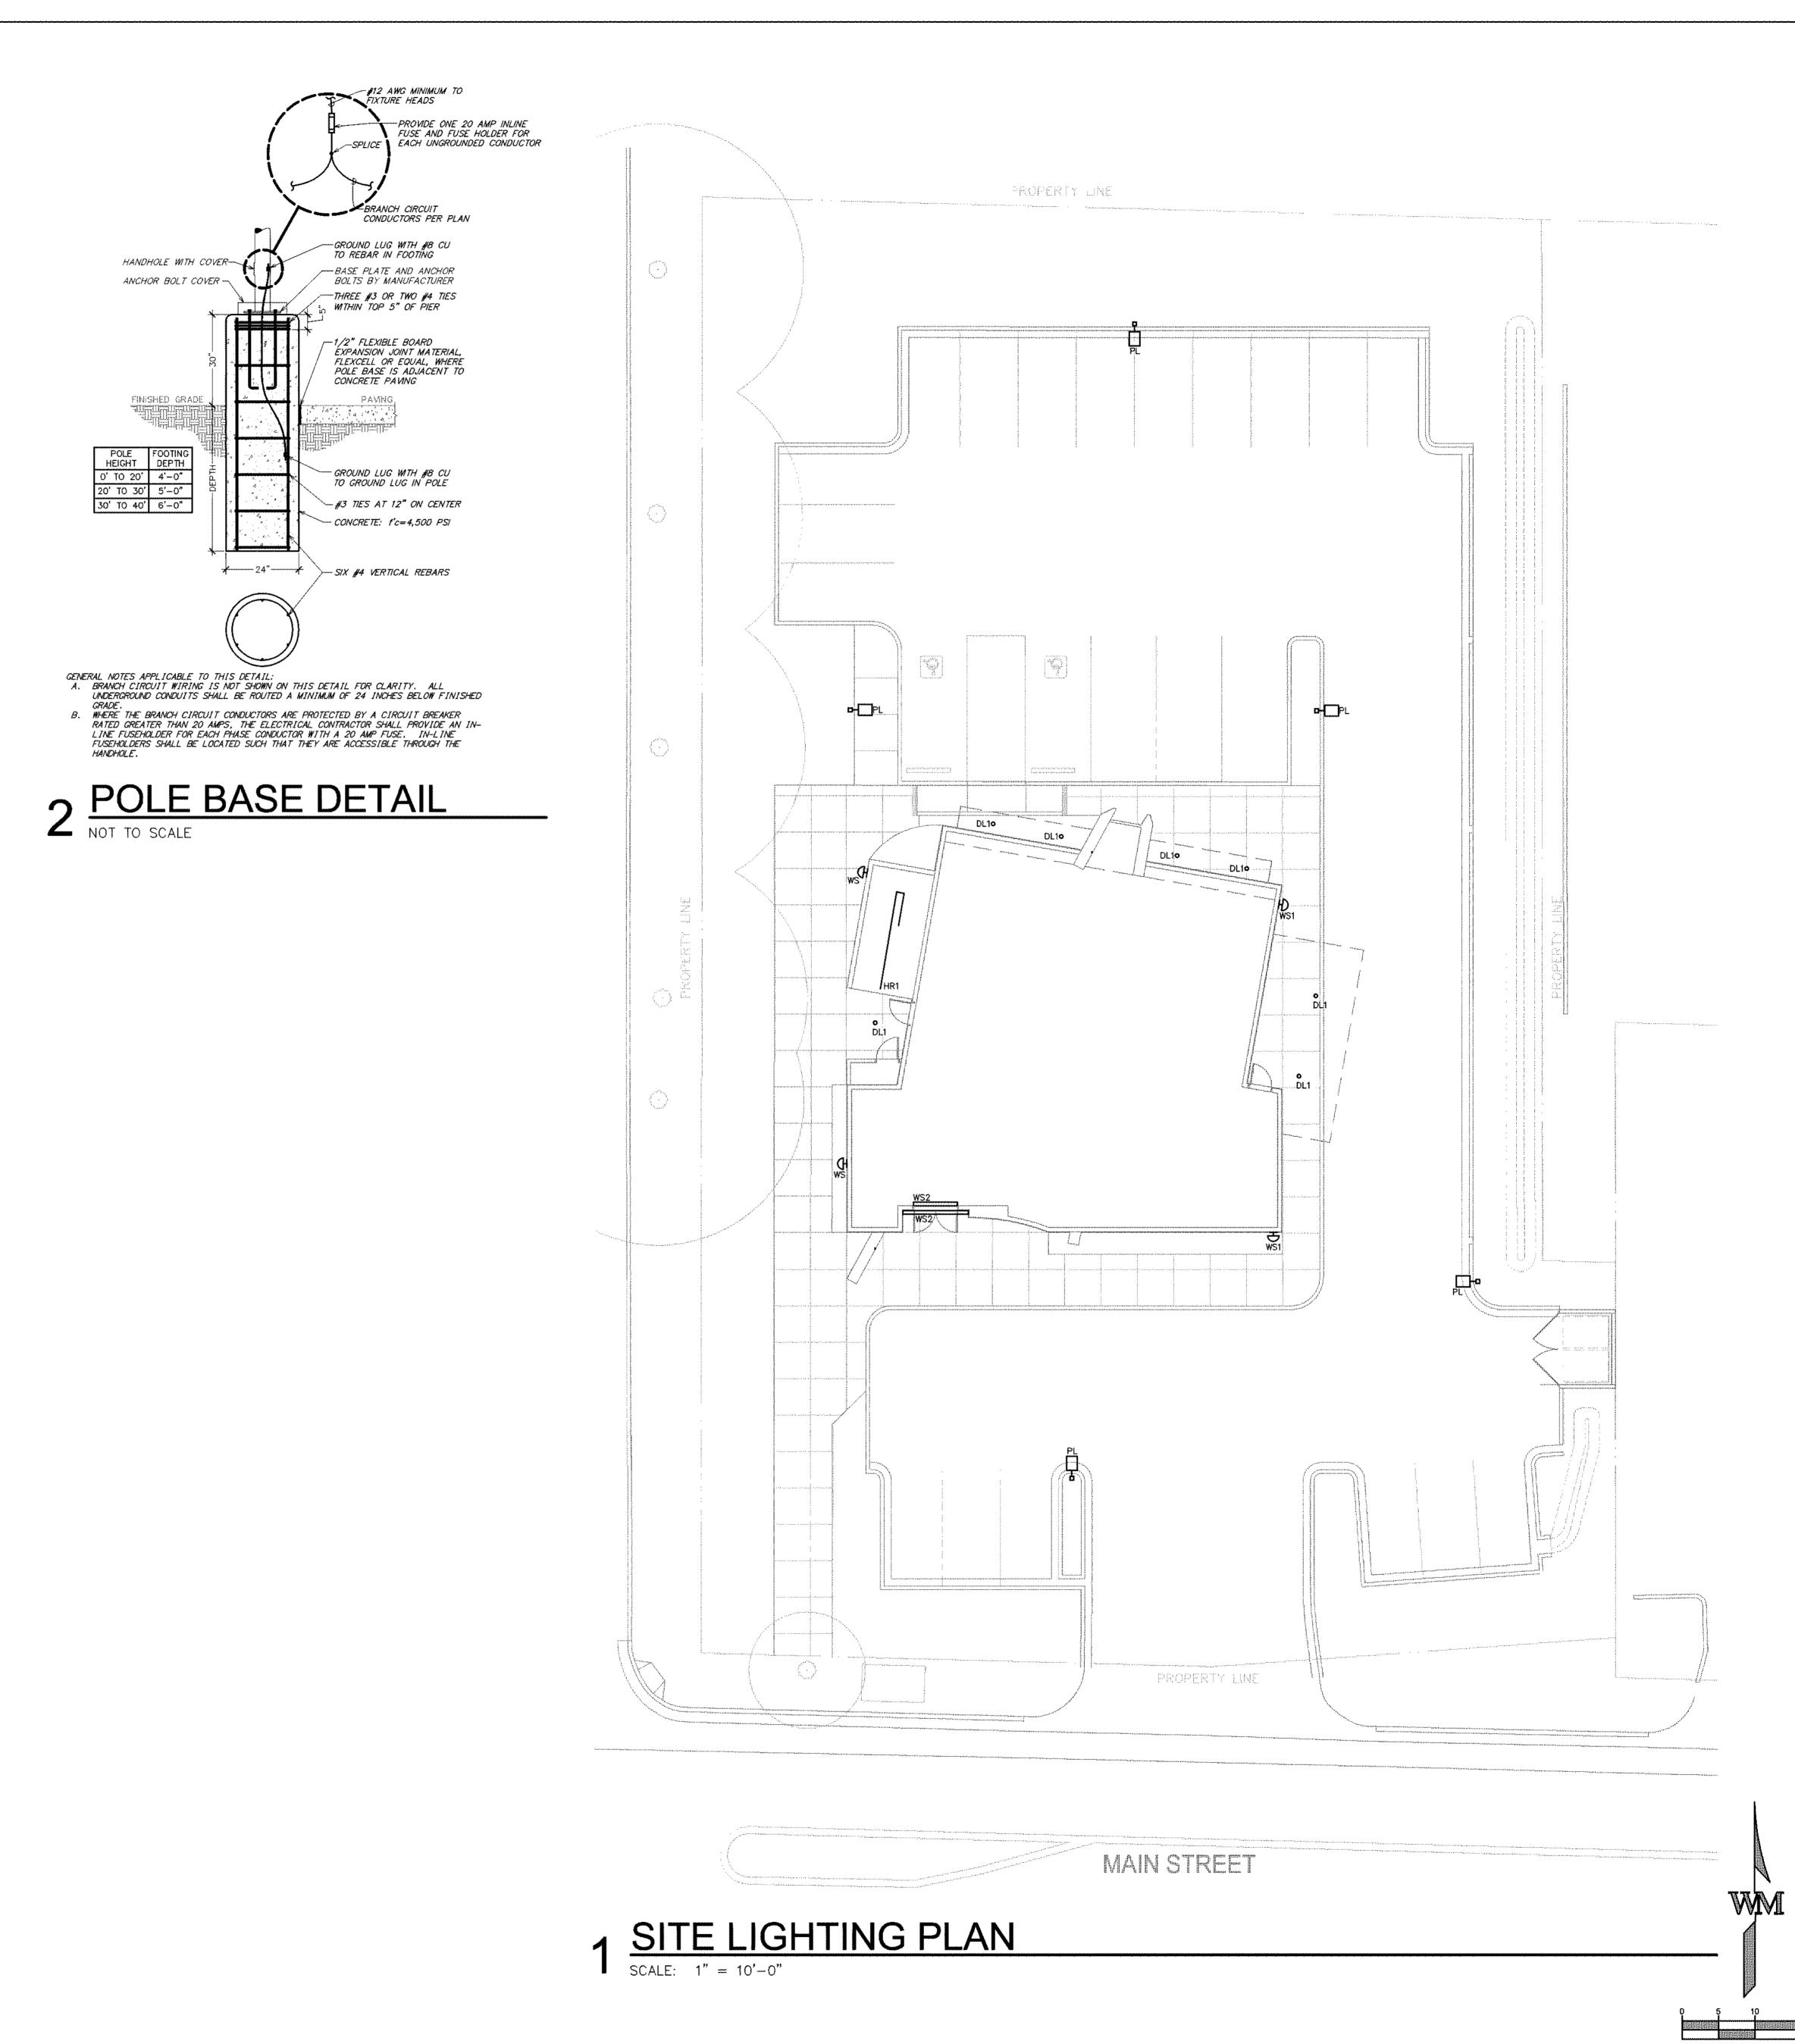

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civil engineering
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p 425.670.6706
f 425.774.8219

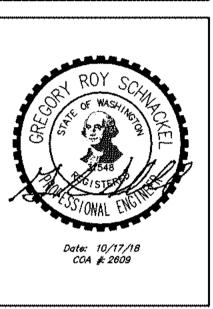

C CENTER OF EASTS
14700 MAIN STREET

TE REMARKS
0-17 SITE DEVELOPMENT SUBMITTAL

/ PM: KAN
AWN BY: SEI
B NO.: SEA18-0022-


PH-1

Schnackel engineers.

800-581-0963 www.schnackel.com

PA / PM: DRAWN BY: RB/BE/CB LA 1831 JOB NO.:

DATE: 10-17-2018

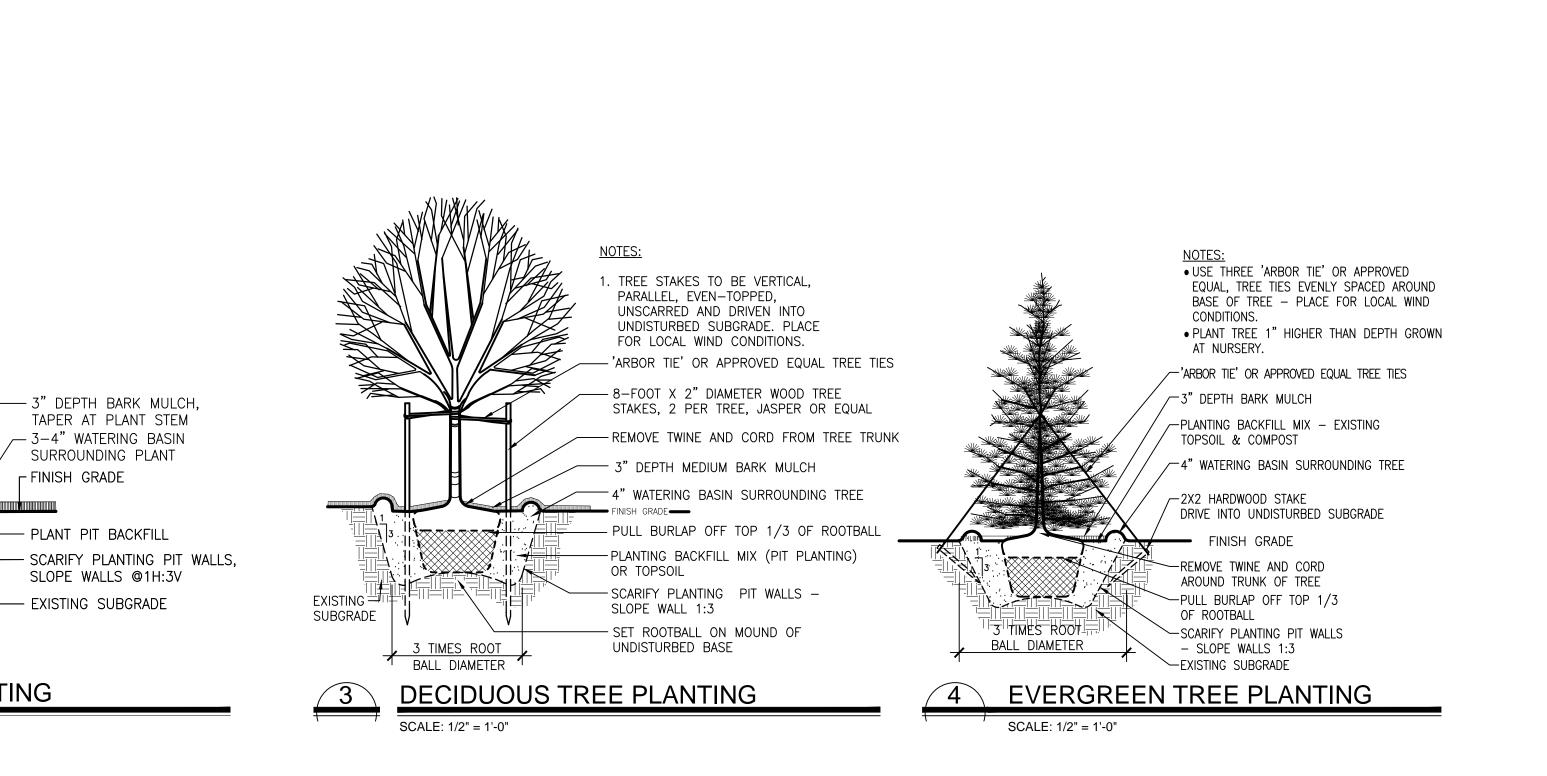

VEGETATED SWALE (TYP) SEE CIVIL PLANS BIO-FILTRATION SWALE EXISTING FENCE 10' WIDTH (TYP) SEE CIVIL PLANS TO REMAIN EVERGREEN TREE (4 LANDSCAPING THRU CURB DRAIN(TYP) PLANTING TYP. SEE CIVIL PLANS EXISTING FENCE SHRUB PLANTING (2) TO REMAIN DECIDUOUS TREE (3 DECORATIVE MIDDLE PLANTING TYP. EASTERN POTS TO ACCENT ENTRIES AND OUTDOOR USE AREAS (TYP) AN AUTOMATIC IRRIGATION SYSTEM WILL BE ALL PLANTING INSTALLED IN TYPE III AREAS ALL PLANTING LANDSCAPING TO RECEIVE 3" AREAS OF BARK MULCH ISLAMIC CENTER OF EASTSIDE SIGN BENCH AT OUTDOOR USE <u>15' WIDTH</u> PLANTING TYP. L1.0 TYPE III LANDSCAPING SHELTER TO REMAIN EXISTING TREE TO REMAIN 0 EXISTING FENCE 10' WIDTH TO REMAIN TYPE III LANDSCAPING 15' ALO IN TRANSITION AREA TO ACCOMODATE OFFSITE TREES IMPACTING SITE (TYP) REQUIRED FACILITY PARKING. TYPE III LANDSCAPE

TAPER AT PLANT STEM

-3-4" WATERING BASIN

SURROUNDING PLANT

PLANT PIT BACKFILL

— EXISTING SUBGRADE

2X ROOTBALL DIA.

SHRUB PLANTING

SLOPE WALLS @1H:3V

FINISH GRADE

- GROUNDCOVER PLANT

EXISTING SUBGRADE

- GROUNDCOVER PLANT

PLANT LIST, TYP.

- EDGE OF PLANTER

INCORPORATES SIGNIFICANT NATIVE TREES &

NATIVE SHRUBS COMBINED WITH A DENSELY

PLANTED N.W. ADAPTED PLANT PALETTE.

SPACING AS INDICATED ON

TOPSOIL DEPTH AND TYPE AS SPECIFIED

GROUNDCOVER PLANTING

- 3" DEPTH BARK MULCH,


TAPER AT PLANT STEM


— 6" MIN. SOIL BENEATH PLANT, TYP.

PLANTING NOTES:

- 1. THE LOCATION OF ALL EXISTING UTILITIES SHALL BE VERIFIED IN THE FIELD BY THE CONTRACTOR. CARE SHALL BE TAKEN TO PROTECT ANY UTILITIES THAT ARE TO REMAIN AND ALL CONSTRUCTION SHALL BE COORDINATED WITH THE APPROPRIATE UTILITY COMPANY. ANY REMOVAL OR RELOCATION SHALL BE DONE BY LOCAL STANDARDS AT THE CONTRACTOR'S EXPENSE. ANY UTILITIES OR SITE FEATURES THAT ARE TO REMAIN OR NEWLY DAMAGED AS A RESULT OF PLANTING ACTIVITIES SHALL BE REPAIRED/OR REPLACED BY THE CONTRACTOR AT NO ADDITIONAL COST TO THE OWNER.
- CAUTION: ALL EXISTING UTILITIES MAY NOT BE SHOWN. PRIOR TO BEGINNING ANY TYPE OF EXCAVATION, THE CONTRACTOR SHALL CONTACT THE LOCAL UTILITY COMPANIES TO MAKE ARRANGEMENTS FOR THE UTILITIES TO BE LOCATED AND MARKED ON THE GROUND. THE CONTRACTOR SHALL MAINTAIN THE UTILITY LOCATION MARKINGS THROUGH COMPLETION OF THE PROJECT
- 2. PRIOR TO SUBMITTING A BID ON THIS PROJECT, THE CONTRACTOR SHALL VISIT THE SITE AND BECOME FAMILIAR WITH THE EXISTING SITE CONDITIONS AND CONSTRAINTS.
- 3. THE CONTRACTOR SHALL BE RESPONSIBLE FOR ALL QUANTITIES, MEASUREMENTS, AND DIMENSIONS. REPORT ANY DISCREPANCIES TO THE LANDSCAPE ARCHITECT IMMEDIATELY FOR A DECISION.
- 4. THE CONTRACTOR SHALL COORDINATE THE WORK WITH ALL OTHER TRADES ON THE SITE. ANY PLANTING AREAS DISTURBED AS A RESULT OF CONSTRUCTION ACTIVITY SHALL BE REPAIRED/REPLACED AT NO ADDITIONAL COST TO THE OWNER.
- 5. ALL PLANT MATERIAL SHALL MEET THE AMERICAN STANDARD FOR NURSERY STOCK (ANSI Z60.1), LATEST EDITION AS PUBLISHED BY THE AMERICAN ASSOCIATION OF NURSERYMEN AND MEET THE MINIMUM SPREADS, HEIGHTS, AND CALIPER MEASUREMENTS AT TIME OF PLANTING. THE PLANT MATERIAL SHALL EXHIBIT NORMAL HABITS OF GROWTH FOR THE SPECIES AND SHALL HAVE BUDS INTACT, AND SHALL BE FREE OF DISEASE, INSECTS, SCARS, BRUISES, BREAKS, SEED AND WEED ROOTS.
- 6. PRIOR TO THE INSTALLATION OF ANY PLANT MATERIAL, THE CONTRACTOR SHALL CONFIRM THAT ALL PLANTING BEDS AND LAWN AREAS ARE WITHIN ONE-INCH OF THE PROPOSED FINISH GRADE AS NOTED ON THE SITE
- GRADING PLAN AND ARE READY TO RECEIVE PLANTING. 7. ALL PLANTING BEDS AND AREAS ARE TO RECEIVE (3) THREE-INCH DEPTH OF SHREDDED HARDWOOD MULCH.
- 8. ALL PLANT MATERIAL SHALL BE GUARANTEED FOR ONE YEAR BEGINNING FROM THE DATE OF WRITTEN APPROVAL FROM THE LANDSCAPE ARCHITECT. PRIOR TO WRITTEN APPROVAL, ALL PLANT MATERIAL SHALL BE MAINTAINED BY THE CONTRACTOR. IT IS THE CONTRACTOR'S RESPONSIBILITY TO PERIODICALLY CHECK THE LANDSCAPING AND MAINTENANCE PROCEDURES AND REPORT THIS INFORMATION TO THE LANDSCAPE ARCHITECT. FAILURE BY THE CONTRACTOR TO REPORT IMPROPER OR LACK OF MAINTENANCE TO THE LANDSCAPE ARCHITECT SHALL IN NO WAY CANCEL OR ALTER THE GUARANTEE OF THE PLANT MATERIAL
- 9. PRIOR TO INSTALLATION OF ANY PLANT MATERIAL; THE CONTRACTOR SHALL CONFIRM ADEQUATE DRAINAGE IN ALL PLANT PITS AND PLANT BEDS AND VERIFY THAT A "HARDPAN" SITUATION DOES NOT EXIST. IMMEDIATELY NOTIFY THE LANDSCAPE ARCHITECT IF A DRAINAGE PROBLEM EXISTS. PROCEEDING TO PLANT, THE CONTRACTOR ACCEPTS THE CONDITIONS OF THE SITE AS FAVORABLE AND READY.
- 10. ANY DEAD PLANT MATERIAL SHALL BE REMOVED IMMEDIATELY FROM THE PLANTING AREAS AT ANY TIME DURING THE TWO (2) YEAR GUARANTEE PERIOD. FIELD REPORTS DESCRIBING REPLACEMENT/GUARANTEE ACTIVITY SHALL BE FILLED OUT AND FORWARDED TO THE LANDSCAPE ARCHITECT ON A MONTHLY BASIS. REPLACEMENT OF DEAD PLANT MATERIAL SHALL BE MADE DURING NORMAL PLANTING SEASONS.
- 11. THE PLANTING SHALL BE COORDINATED WITH OTHER WORK ACTIVITIES, INCLUDING IRRIGATION. COORDINATE ALL WORK WITH OTHER TRADES AS NECESSARY.
- 12. ALL PLANTED AREAS ARE TO BE IRRIGATED WITH A BELOW GRADE, AUTOMATICALLY CONTROLLED IRRIGATION SYSTEM. SEE IRRIGATION PLANS
- 13. PLANTING BEDS (EXCLUDING RAISED PLANTERS, POTS & PIT PLANTINGS) AND TURF AREAS SHALL RECEIVE 8-INCH COMPACTED DEPTH (85% COMPACT) IMPORTED TOPSOIL. FIRST 2-INCH LIFT SHALL BE THOROUGHLY MIXED INTO EXISTING SUBSOIL TO A 4-INCH MINIMUM DEPTH.

PLANT SCHEDULE

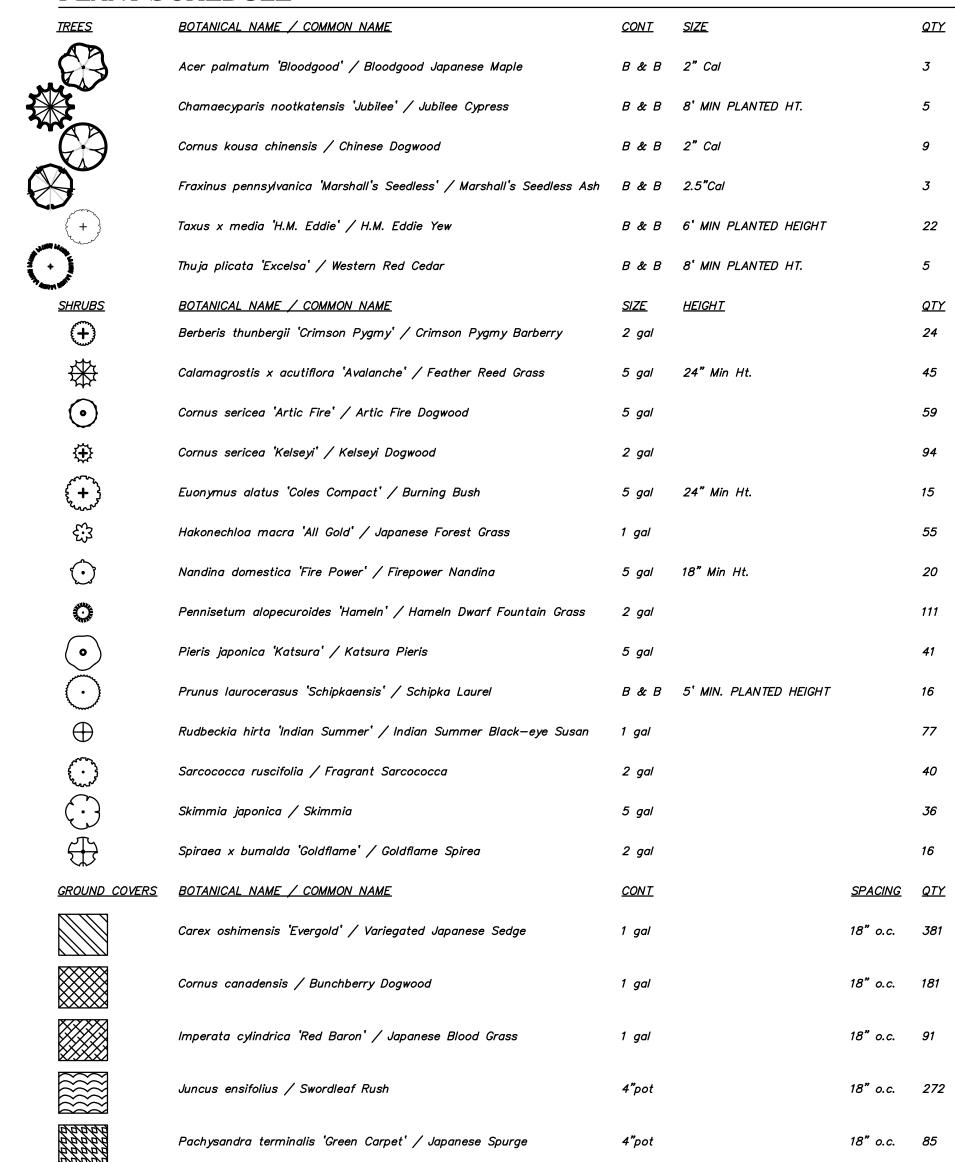

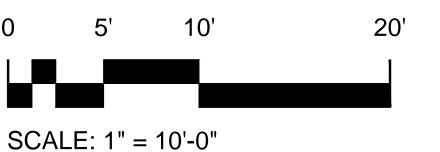





CONT SIZE

B & B 2" Cal

B & B 2" Cal

B & B 8' MIN PLANTED HT.

B & B 6' MIN PLANTED HEIGHT

B & B 8' MIN PLANTED HT.



QTY

BOTANICAL NAME / COMMON NAME Berberis thunbergii 'Crimson Pygmy' / Crimson Pygmy Barberry Calamagrostis x acutiflora 'Avalanche' / Feather Reed Grass Comus sericea 'Artic Fire' / Artic Fire Dogwood Cornus sericea 'Kelseyi' / Kelseyi Dogwood Euonymus alatus 'Coles Compact' / Burning Bush 5 gal 24" Min Ht. Hakonechioa macra 'All Gold' / Japanese Forest Grass Nandina domestica 'Fire Power' / Firepower Nandina Pennisetum alopecuroides 'Hameln' / Hameln Dwarf Fountain Grass Pieris japonica 'Katsura' / Katsura Pieris B & B 5' MIN. PLANTED HEIGHT Prunus laurocerasus 'Schipkaensis' / Schipka Laurel Rudbeckia hirta 'Indian Summer' / Indian Summer Black-eye Susan Sarcococca ruscifolia / Fragrant Sarcococca Skimmia japonica / Skimmia Spiraea x bumalda 'Goldflame' / Goldflame Spirea SPACING QTY GROUND COVERS BOTANICAL NAME / COMMON NAME Carex oshimensis 'Evergold' / Variegated Japanese Sedge 18" o.c. 381 18" o.c. 181 Cornus canadensis / Bunchberry Dogwood 1 gal 18" o.c. 91 Imperata cylindrica 'Red Baron' / Japanese Blood Grass Juncus ensifolius / Swordleaf Rush 18" o.c. 272 Pachysandra terminalis 'Green Carpet' / Japanese Spurge 18" o.c. 85

Fraxinus pennsylvanica 'Marshall's Seedless' / Marshall's Seedless Ash B & B 2.5"Cal

SCALE: 1" = 10'-0"

PLANT SCHEDULE

BOTANICAL NAME / COMMON NAME

Taxus x media 'H.M. Eddie' / H.M. Eddie Yew

Thuja plicata 'Excelsa' / Western Red Cedar







BIO-FILTRATION SWALE (TYP) SEE CIVIL PLANS

10' WIDTH TYPE III

LANDSCAPING

EXISTING FENCE TO REMAIN

VEGETATED SWALE (TYP) SEE CIVIL PLANS

TRASH ENCLOSURE

THRU CURB DRAIN(TYP)
SEE CIVIL PLANS

SITE AMENITIES & PLANTING PALETTE - ISLAMIC CENTER OF EASTSIDE

DECIDUOUS TREES



COLUMNAR HORNBEAM



MARSHALL'S GREEN ASH



JAPANESE BLOODGOOD MAPLE



DWARF BURNING BUSH



AVALANCHE REED GRASS DWARF FOUNTAIN GRASS





REDTWIG DOGWOOD

EVERGREEN TREES



EXCELSA WESTERN RED CEDAR

GROUNDCOVER





WEEPING ALASKA CEDAR






JAPANESE PIERIS





SCHIPKA LAUREL

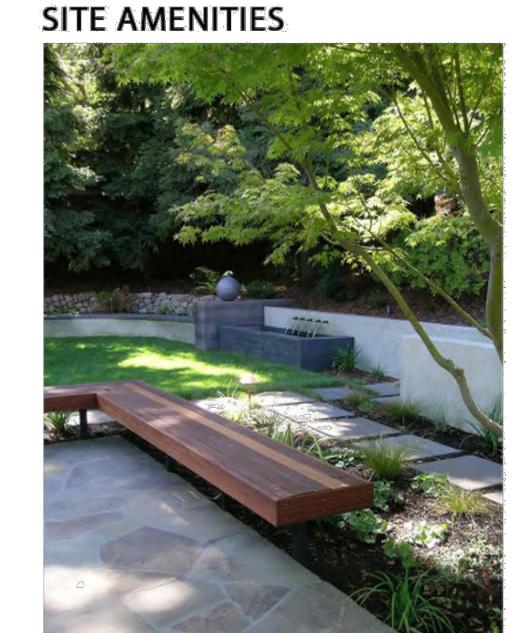



BENCH

PLANTER POTS

		30	*
EVERGOLD	S	ED	GE





BUNCHBERRY



JAPANESE FOREST GRASS

